

Project Drawings


A1601013

Exhibit B3 – Roadway Drawings

Exhibit B3-1 - Avenue 7


PAVEMENT SECTION APPLICABLE WHEN THE UPPER 4 FEET OF NEW EMBANKMENT MATERIALS (MEASURED FROM THE GRADING PLANE) POSSESS A MINIMUM R-VALUE OF 50 AND A PLASTICITY INDEX OF LESS THAN 12%. WHERE SUBGRADE DOES NOT MEET THESE REQUIREMENTS, SEE GEOTECHNICAL ENGINEERING DESIGN REPORT AVE 7 OVERHEAD (NEW) FOR

- NOTES:
- 1. SEE DRAWING ST-K1100-A07 FOR TYPICAL SECTION BB STA. 17+97.81 TO EB STA. 19+93.81.
- 2. FOR EXISTING PAVEMENT MILLING AND OVERLAY LOCATIONS, SEE LAYOUT PLANS
- 3. FOR SHOULDER SLOPE TRANSITION AT BRIDGE APPROACHES, SEE CV-CD001-A7A
- 4. SEE LAYOUT PLANS FOR MGS AND DIKE LIMITS
- 5. EARTHWORK SHALL BE CONSTRUCTED IN ACCORDANCE WITH THE MADERA COUNTY SPECIFICATIONS, COUNTY OF MADERA SPECIAL PROVISIONS AND THE CONSTRUCTION RECOMMENDATIONS PRESENTED IN THE AVENUE 7 GEOTECHNICAL ENGINEERING DESIGN REPORT

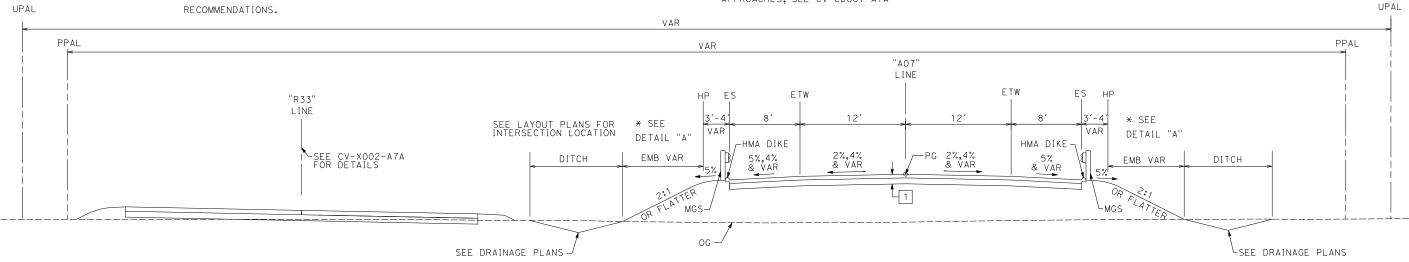

AVENUE 7

STA. 19+93.81 TO STA.32+05.00

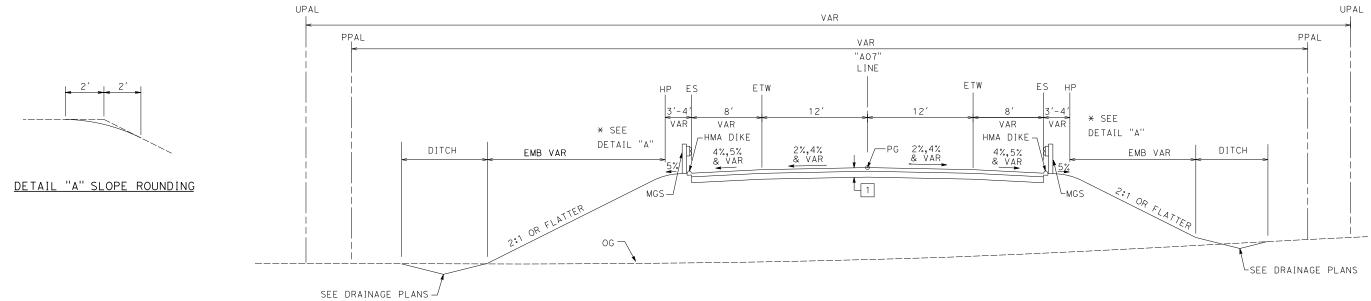

AVENUE 7

STA. 11+73.12 TO STA. 17+97.81 STA. 32+05.00 TO STA. 44+00.00

| DESIGNED BY | J. HANNA | DESIGNED BY | J. HANNA | DESIGNED BY | J. HANNA | DESIGNED BY | DESIGNED








CALIFORNIA HIGH-SPEED TRAIN PROJECT CONSTRUCTION PACKAGE 1

AVENUE 7 ATC GRADE SEPARATION
TYPICAL SECTIONS
SHEET 1 OF 4

Exhibit B3-1.1					
	CONTRACT NO. HSR13-06				
	DRAWING NO. CV-XOO1-A7A				
	1" = 50'				
	SHEET NO.				

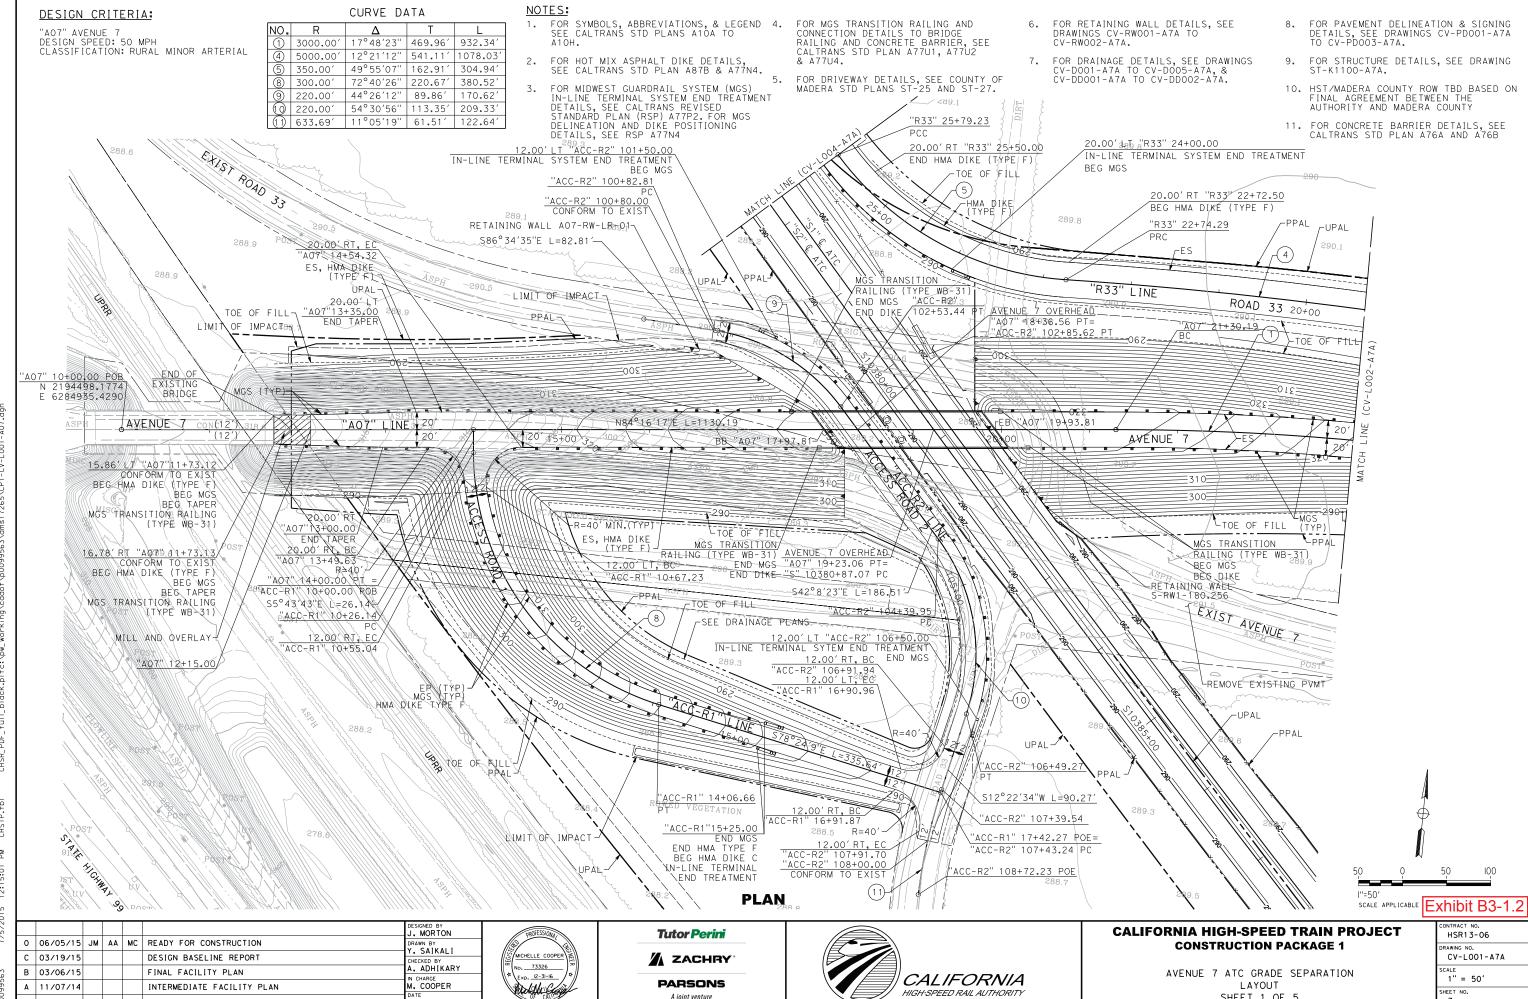

A joint venture


SHEET 1 OF 5

DATE

NO.	R	Δ	Т	L
1	3000.00′	17°48′23"	469.96′	932.34′
3	80.00′	91°40′52"	82.38'	128.01
(4)	5000.00'	12°21′12"	541.11′	1078.03

NOTE:

1. SEE DRAWING CV-LOO1-A7A FOR NOTES.

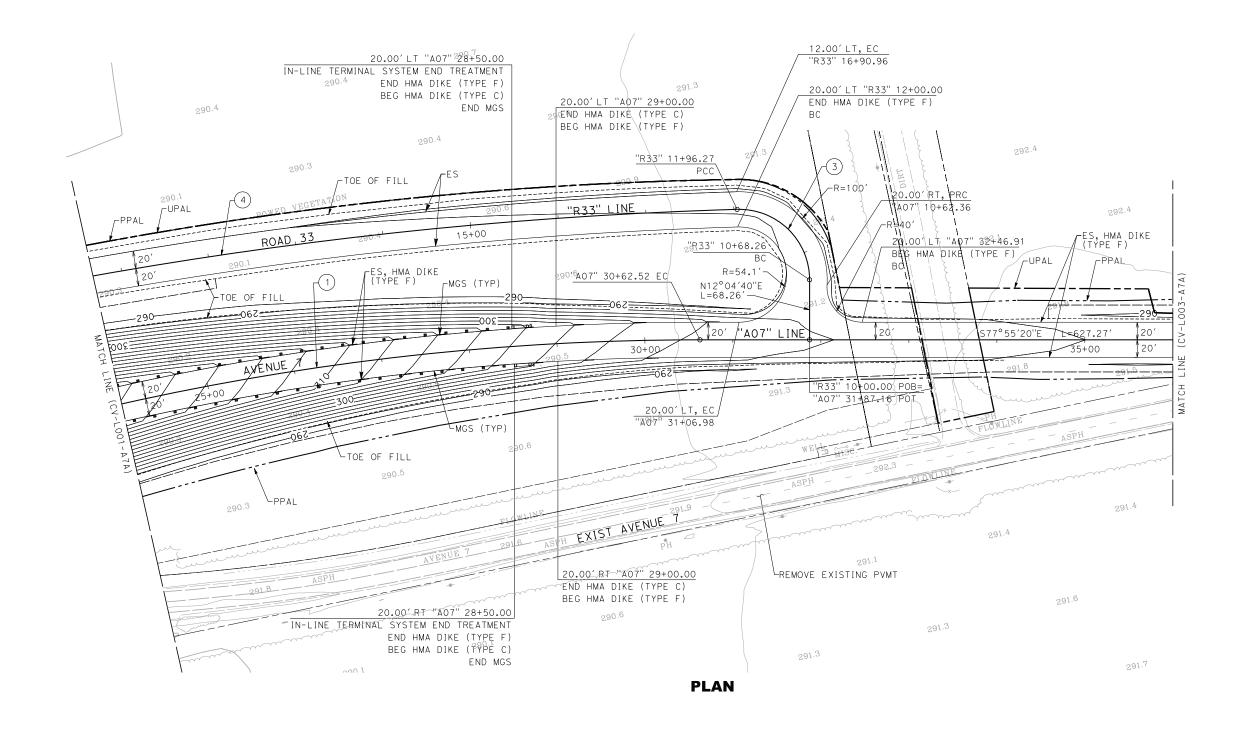



SCALE APPLICABLE FOR FULL SIZE ONLY

-							J. HANNA
ì	0	06/05/15	JH	AA	MC	READY FOR CONSTRUCTION	DRAWN BY Y. SAIKALI
	С	03/19/15				DESIGN BASELINE REPORT	CHECKED BY
1	В	03/06/15				FINAL FACILITY PLAN	A. ADHIKARY IN CHARGE
06600	Α	11/07/14				INTERMEDIATE FACILITY PLAN	M. COOPER
3	REV	DATE	BY	СНК	APP	DESCRIPTION	06/05/15



Tutor Perini

ZACHRY

PARSONS


A joint venture




CALIFORNIA HIGH-SPEED TRAIN PROJECT CONSTRUCTION PACKAGE 1

AVENUE 7 ATC GRADE SEPARATION LAYOUT SHEET 2 OF 5

COUNT B3-1.3				
CONTRACT NO. HSR13-06				
CV-LOO2-A7A				
1" = 50'				
SHEET NO. 8				

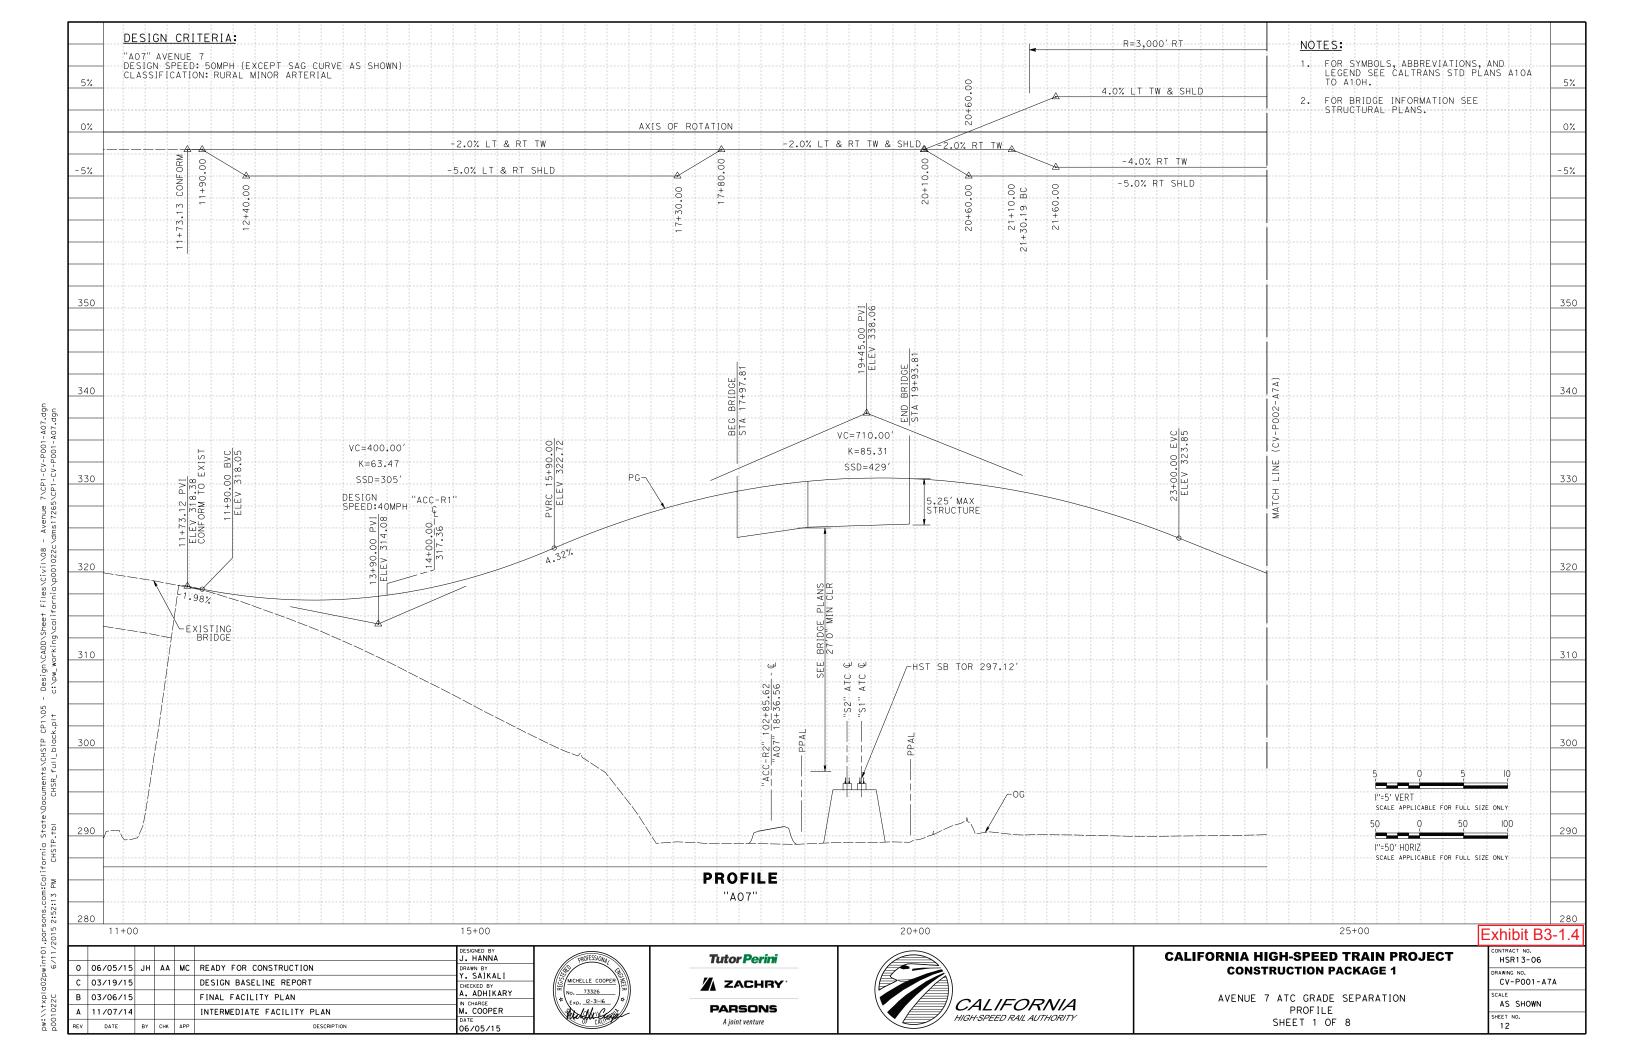

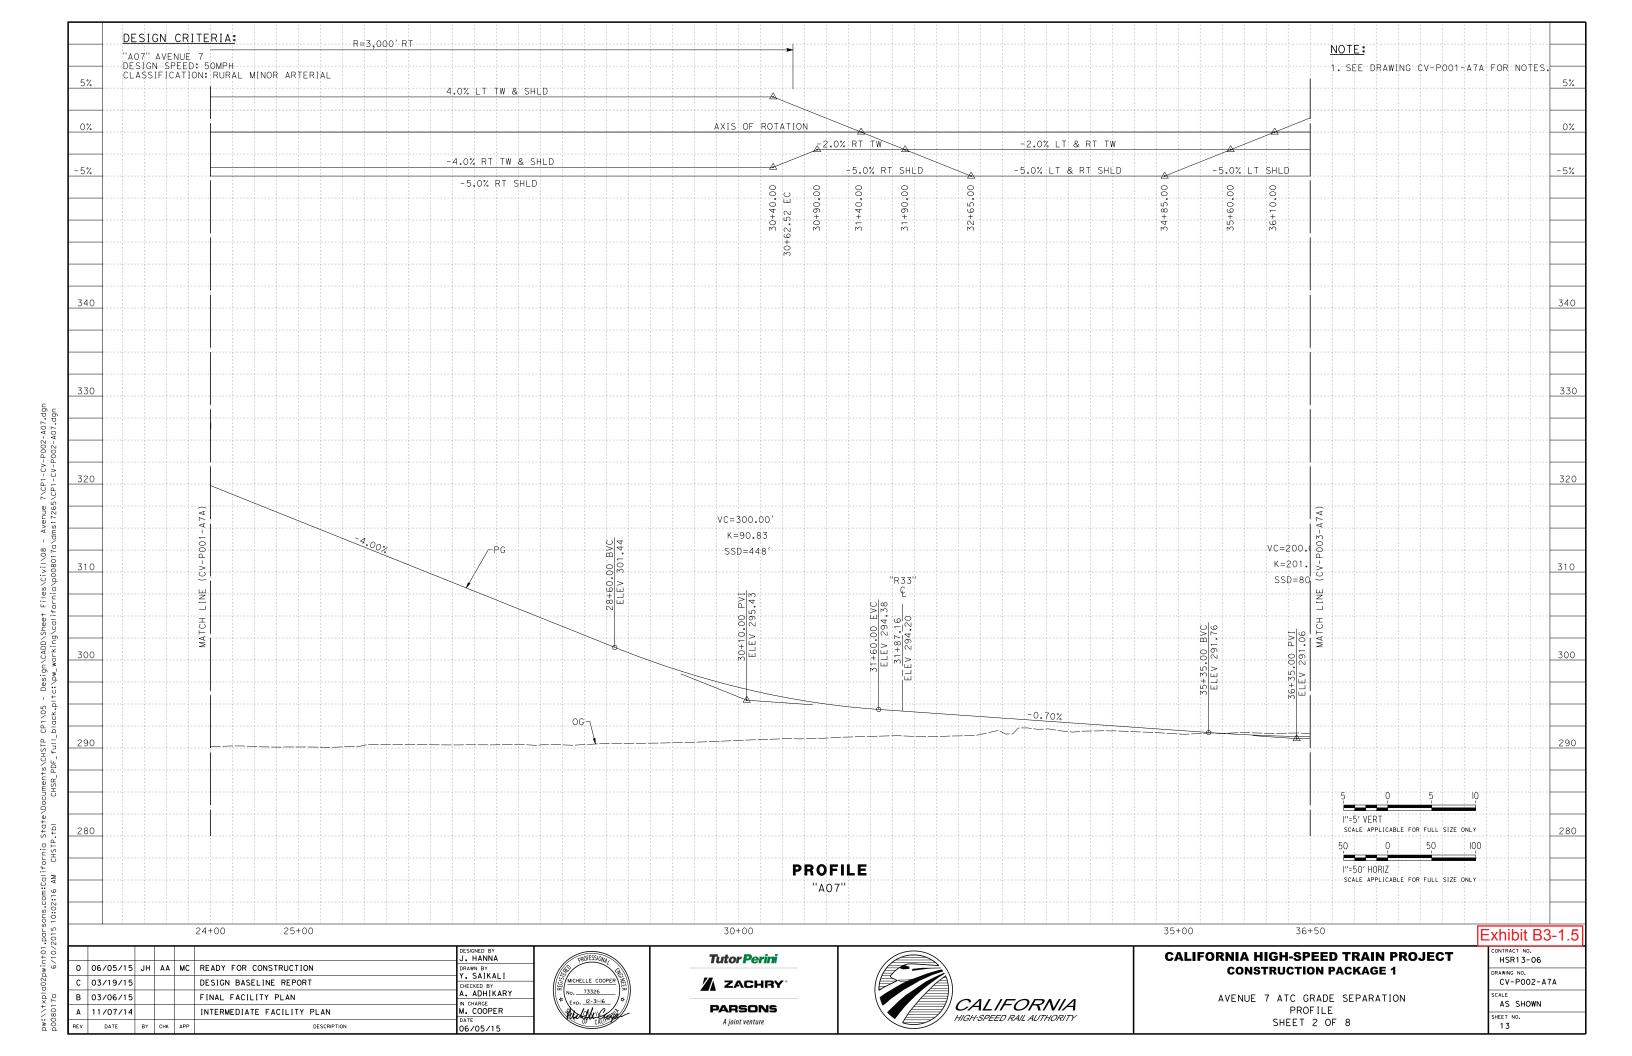


Project Drawings

Exhibit B3 – Roadway Drawings

Exhibit B3-2 - Avenue 8


1 0.25' HMA-A 0.35' CLASS 2 AB

PAVEMENT SECTION APPLICABLE WHEN THE UPPER 4 FEET OF NEW EMBANKMENT MATERIALS (MEASURED FROM THE GRADING PLANE) POSSESS A MINIMUM R-VALUE OF 50 AND A PLASTICITY INDEX OF LESS THAN 12%. WHERE SUBGRADE DOES NOT MEET THESE REQUIREMENTS, SEE GEOTECHNICAL ENGINEERING DESIGN REPORT AVE 8 OVERHEAD (NEW) FOR RECOMMENDATIONS.

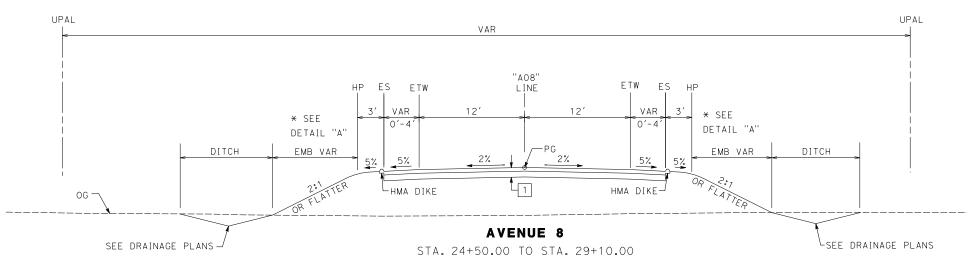

NOTE:

- 1. SEE STRUCTURES DRAWING ST-K3350-A8A FOR TYPICAL SECTION BB STA. 14+86.45 TO EB STA. 15+99.45.
- 2. FOR EXISTING PAVEMENT MILLING AND OVERLAY LOCATIONS, SEE LAYOUT PLANS
- 3. FOR SHOULDER SLOPE TRANSITION AT BRIDGE APPROACHES, SEE CV-CD001-A8A
- 4. SEE LAYOUT PLANS FOR MGS AND DIKE LIMITS
- 5. EARTHWORK SHALL BE CONSTRUCTED IN ACCORDANCE WITH THE MADERA COUNTY SPECIFICATIONS, COUNTY OF MADERA SPECIAL PROVISIONS AND THE CONSTRUCTION RECOMMENDATIONS PRESENTED IN THE AVENUE 8 GEOTECHNICAL ENGINEERING DESIGN REPORT

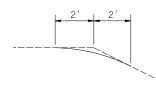

DETAIL "A" SLOPE ROUNDING

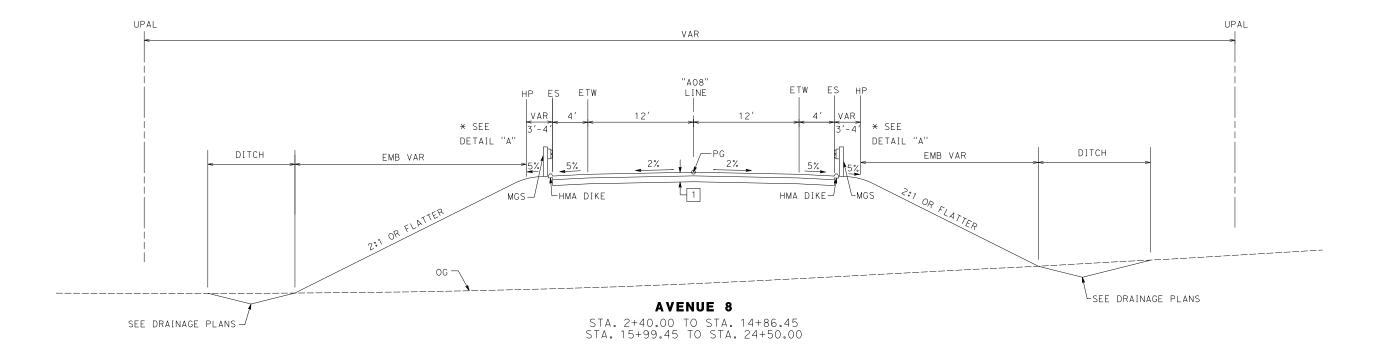


Exhibit B3-2.1

: L							J. HANNA
ò	0	06/05/15	JH	AA	мс	READY FOR CONSTRUCTION	DRAWN BY Y. SAIKALI
	С	03/19/15				DESIGN BASELINE REPORT	CHECKED BY
2	В	03/06/15				FINAL FACILITY PLAN	A. ADHIKARY IN CHARGE
	Α	11/07/14				INTERMEDIATE FACILITY PLAN	M. COOPER
2	REV	DATE	BY	СНК	APP	DESCRIPTION	06/05/2015







CALIFORNIA HIGH-SPEED TRAIN PROJECT CONSTRUCTION PACKAGE 1

AVENUE 8 ATC GRADE SEPARATION TYPICAL SECTIONS


CONTRACT NO. HSR13-06
H2K12-06
DRAWING NO.
CV-X001-A8A
SCALE
NO SCALE
SUFET NO

DESIGN CRITERIA:

"AO8" AVENUE 8
DESIGN SPEED: 55MPH CLASSIFICATION: RURAL LOCAL STREET

NOTES:

- FOR SYMBOLS, ABBREVIATIONS, & LEGEND 5. SEE CALTRANS STD PLANS A10A TO
- FOR HOT MIX ASPHALT DIKE DETAILS, SEE CALTRANS STD PLAN A87B AND
- FOR MIDWEST GUARDRAIL SYSTEM (MGS) IN-LINE TERMINAL SYSTEM END
 TREATMENT DETAILS, SEE CALTRANS
 REVISED STANDARD PLAN (RSP) A77P2.
 FOR MGS DELINEATION AND DIKE
 POSITIONING DETAILS, SEE RSP A77N4.
- FOR MGS TRANSITION RAILING AND CONNECTION DETAILS TO THE BRIDGE RAILING, SEE CALTRANS STD PLAN A77U4, A77U1 AND A77U2.
- FOR DRIVEWAY DETAILS, SEE COUNTY OF MADERA STD PLANS ST-25 AND ST-27. 2.5" HMA OVER 6" AB.
- FOR RETAINING WALL DETAILS, SEE DRAWINGS CV-RWOO1-A8A TO CV-RWOO2-A8A.
- 7. FOR DRAINAGE DETAILS, SEE DRAWINGS CV-D001-A8A TO CV-D003-A8A, & CV-DP001-A8A TO CV-DD001-A8A.
- FOR PAVEMENT DELINEATION & SIGNING DETAILS, SEE DRAWINGS CV-PD001-A8A TO CV-PD003-A8A.

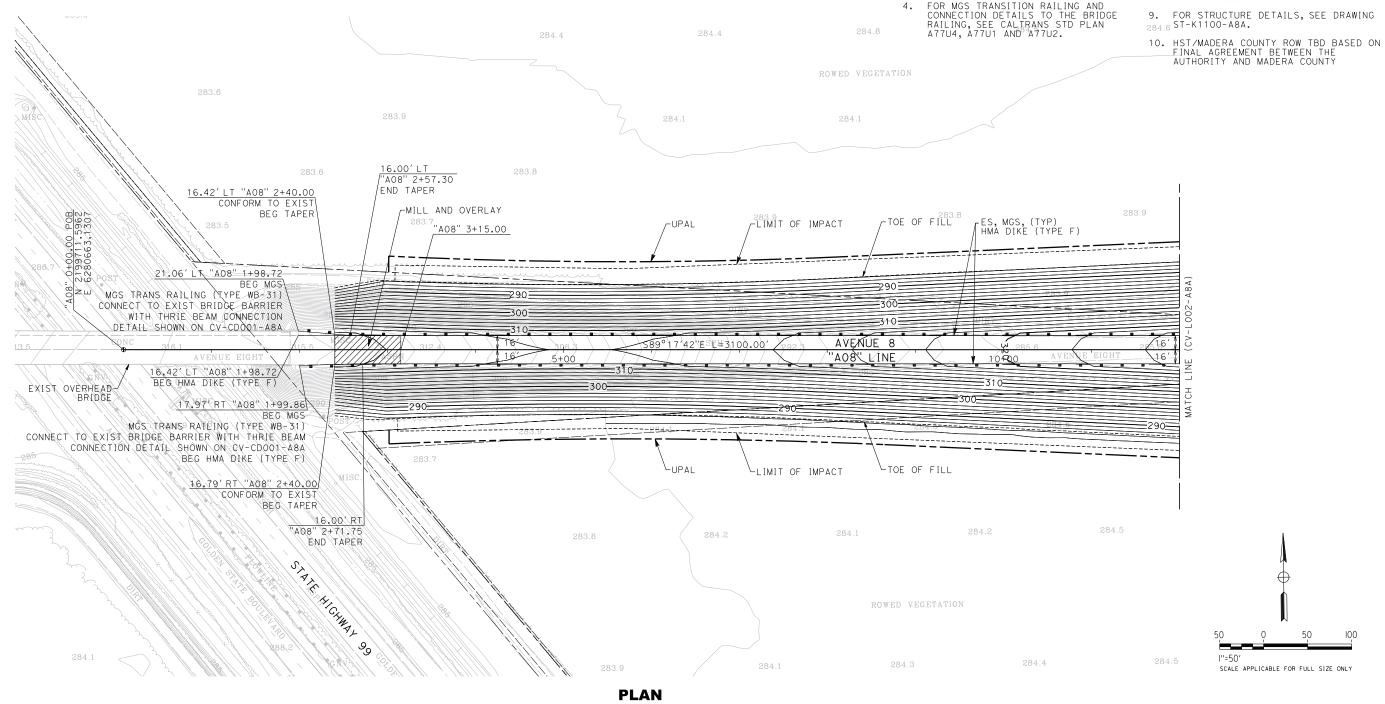

. HANNA 0 06/05/15 JH AA MC READY FOR CONSTRUCTION . SAIKALI C 03/19/15 DESIGN BASELINE REPORT HECKED BY B 03/06/15 FINAL FACILITY PLAN M. COOPER A 11/07/14 INTERMEDIATE FACILITY PLAN

DATE



Tutor Perini ZACHRY **PARSONS** A joint venture



CALIFORNIA HIGH-SPEED TRAIN PROJECT CONSTRUCTION PACKAGE 1


AVENUE 8 ATC GRADE SEPARATION LAYOUT SHEET 1 OF 3


	exhibit B3-2.						
	CONTRACT NO. HSR13-06						
	DRAWING NO. CV-LOO1-A8A						
	1" = 50'						
	SHEET NO.						

REV DATE BY CHK APP



SEE SHEET CV-LOO1-A8A FOR NOTES.

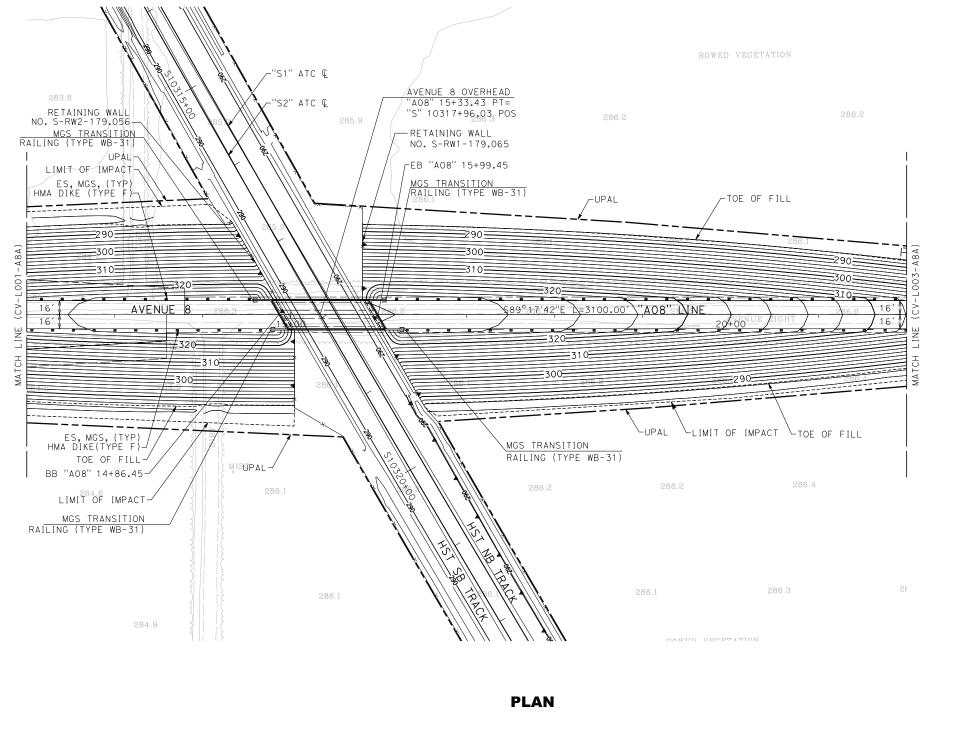

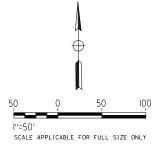

						J. HANNA
0	06/05/15	JH	AA	MC	READY FOR CONSTRUCTION	DRAWN BY Y. SAIKALI
С	03/19/15				DESIGN BASELINE REPORT	CHECKED BY
В	03/06/15				FINAL FACILITY PLAN	A. ADHIKARY IN CHARGE
Α	11/07/14				INTERMEDIATE FACILITY PLAN	M. COOPER



Tutor Perini

ZACHRY

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CALIFORNIA HIGH-SPEED TRAIN PROJECT CONSTRUCTION PACKAGE 1

AVENUE 8 ATC GRADE SEPARATION LAYOUT SHEET 2 OF 3

CONTRACT NO. HSR13-06
DRAWING NO. CV-LOO2-A8A
1" = 50'
SHEET NO.

Exhibit B3-2.3

Exhibit B3-2.4

ù							J. HANNA
هٔ	0	06/05/15	JH	AA	MC	READY FOR CONSTRUCTION	DRAWN BY Y. SAIKALI
	С	03/19/15				DESIGN BASELINE REPORT	CHECKED BY
₹.	В	03/06/15				FINAL FACILITY PLAN	A. ADHIKARY
ceeood	Α	11/07/14				INTERMEDIATE FACILITY PLAN	M. COOPER
000	REV	DATE	BY	СНК	APP	DESCRIPTION	DATE 06/05/15









CALIFORNIA HIGH-SPEED TRAIN PROJECT CONSTRUCTION PACKAGE 1


NOTE:

AVENUE 8 ATC GRADE SEPARATION
LAYOUT
SHEET 3 OF 3

CONTRACT NO.
HSR13-06
DRAWING NO.
CV-L003-A8A
SCALE
1" = 50'
SHEET NO.
6

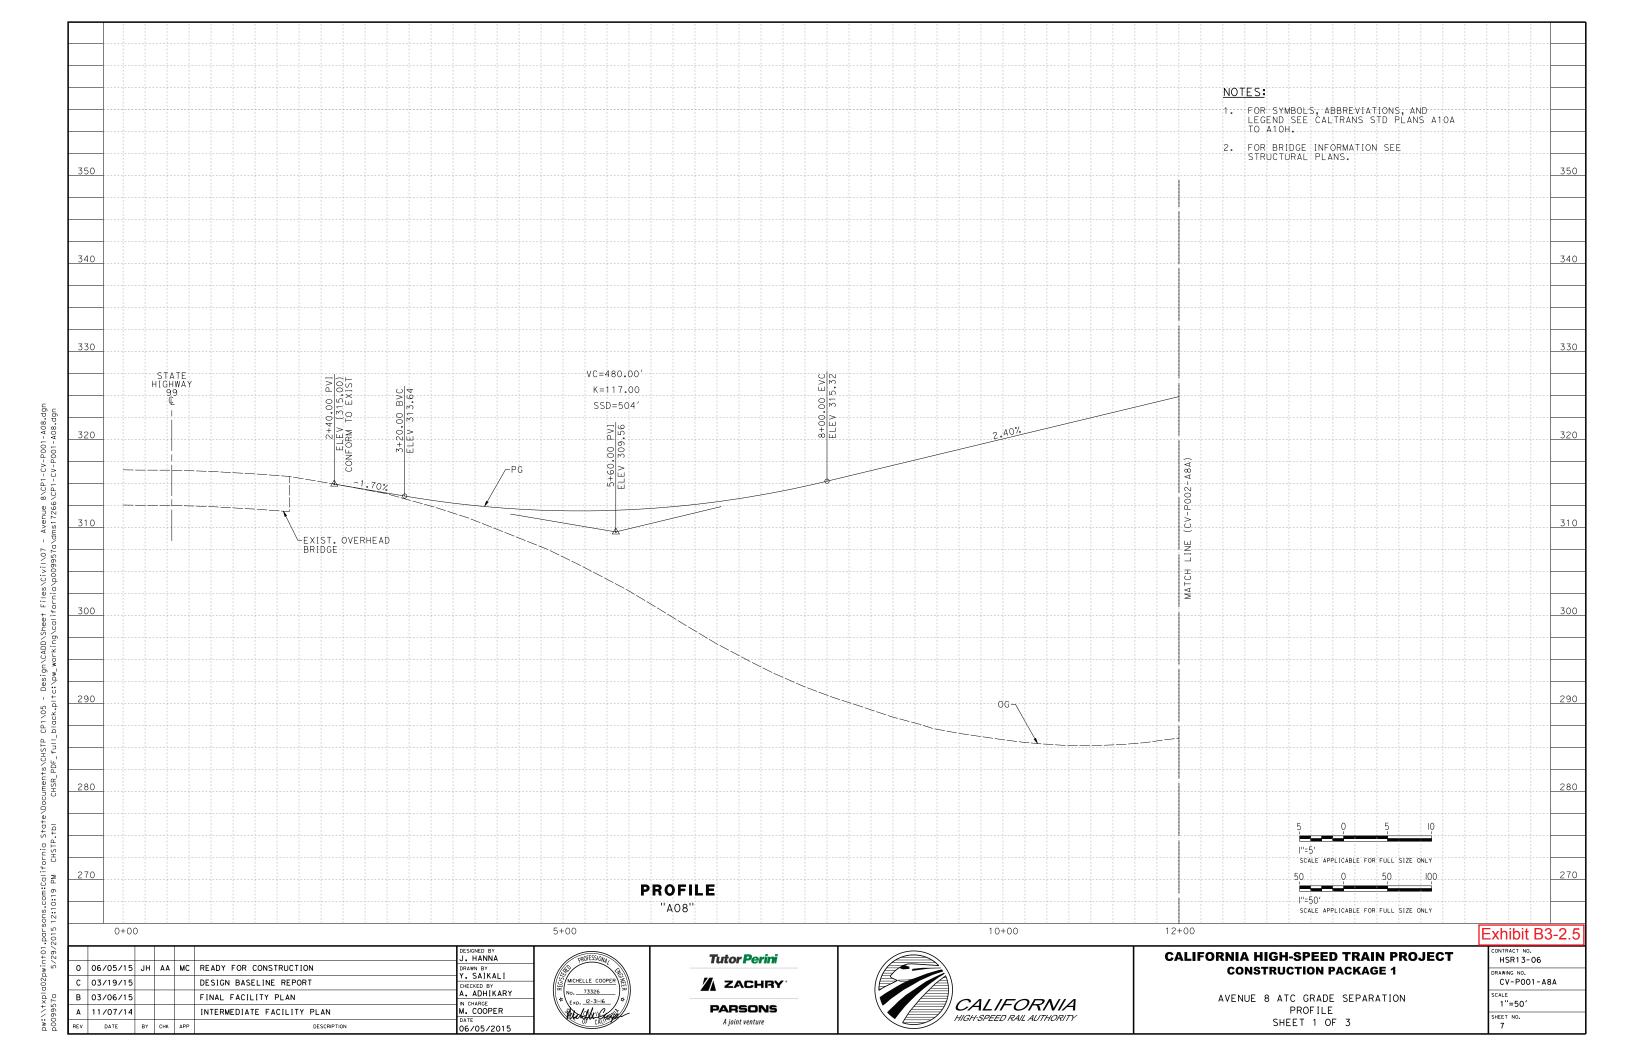

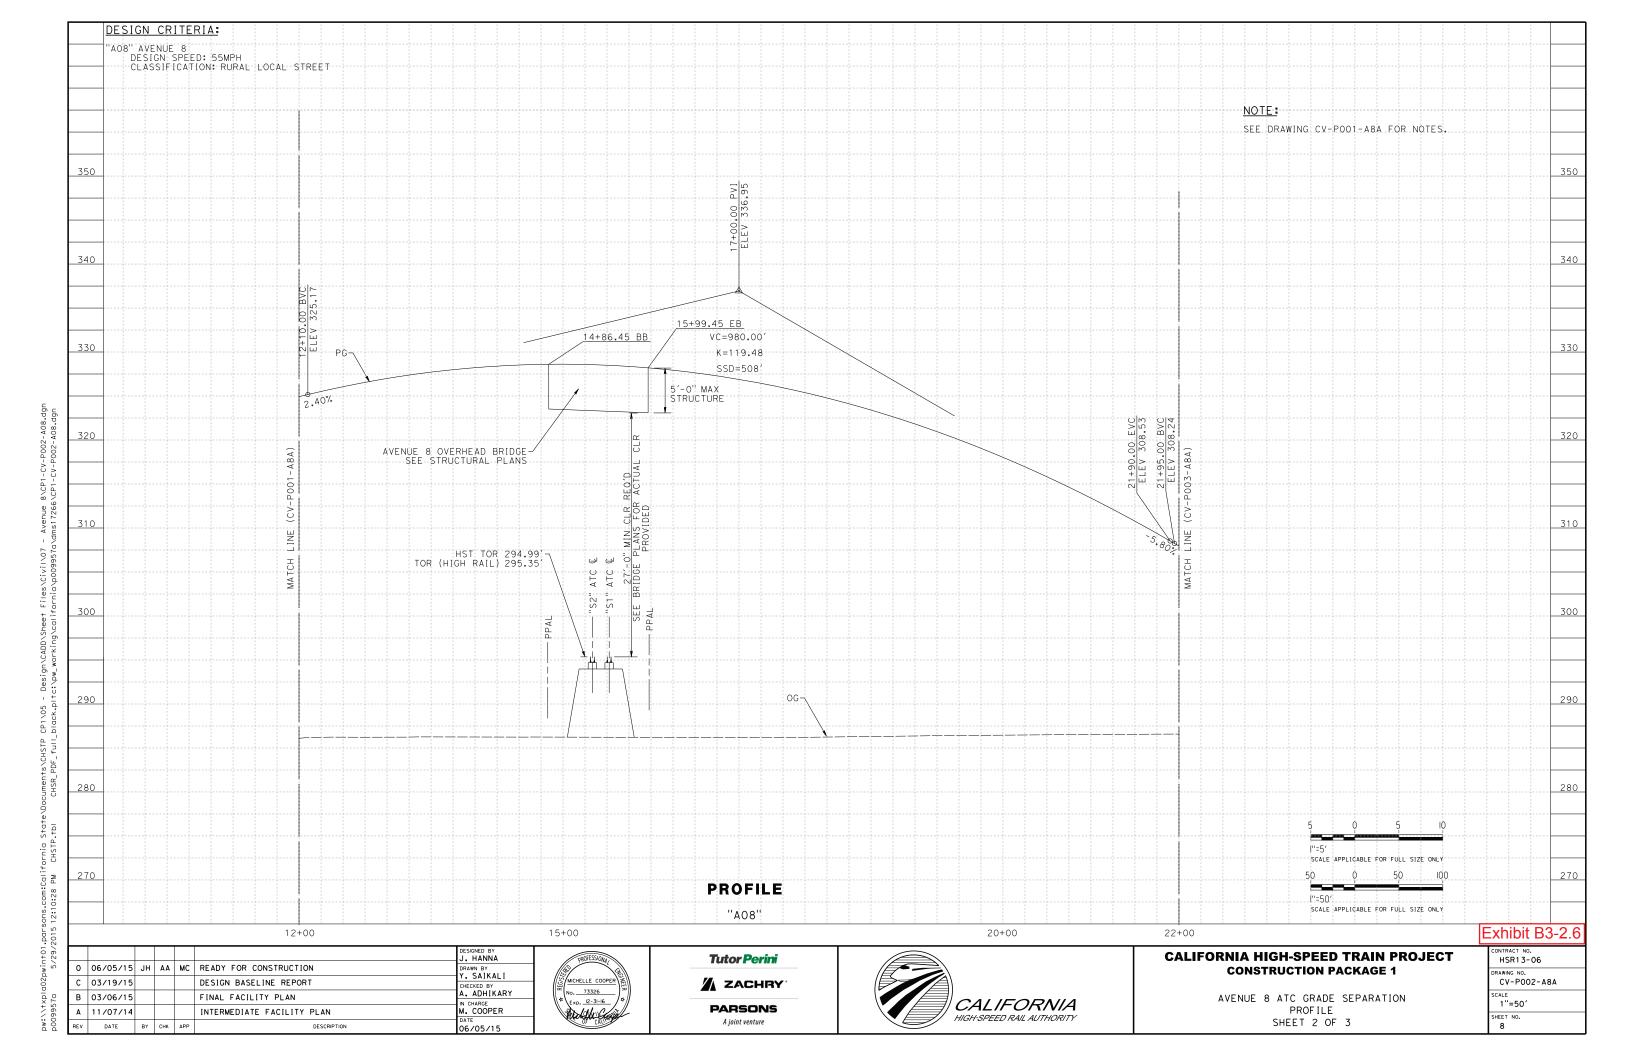

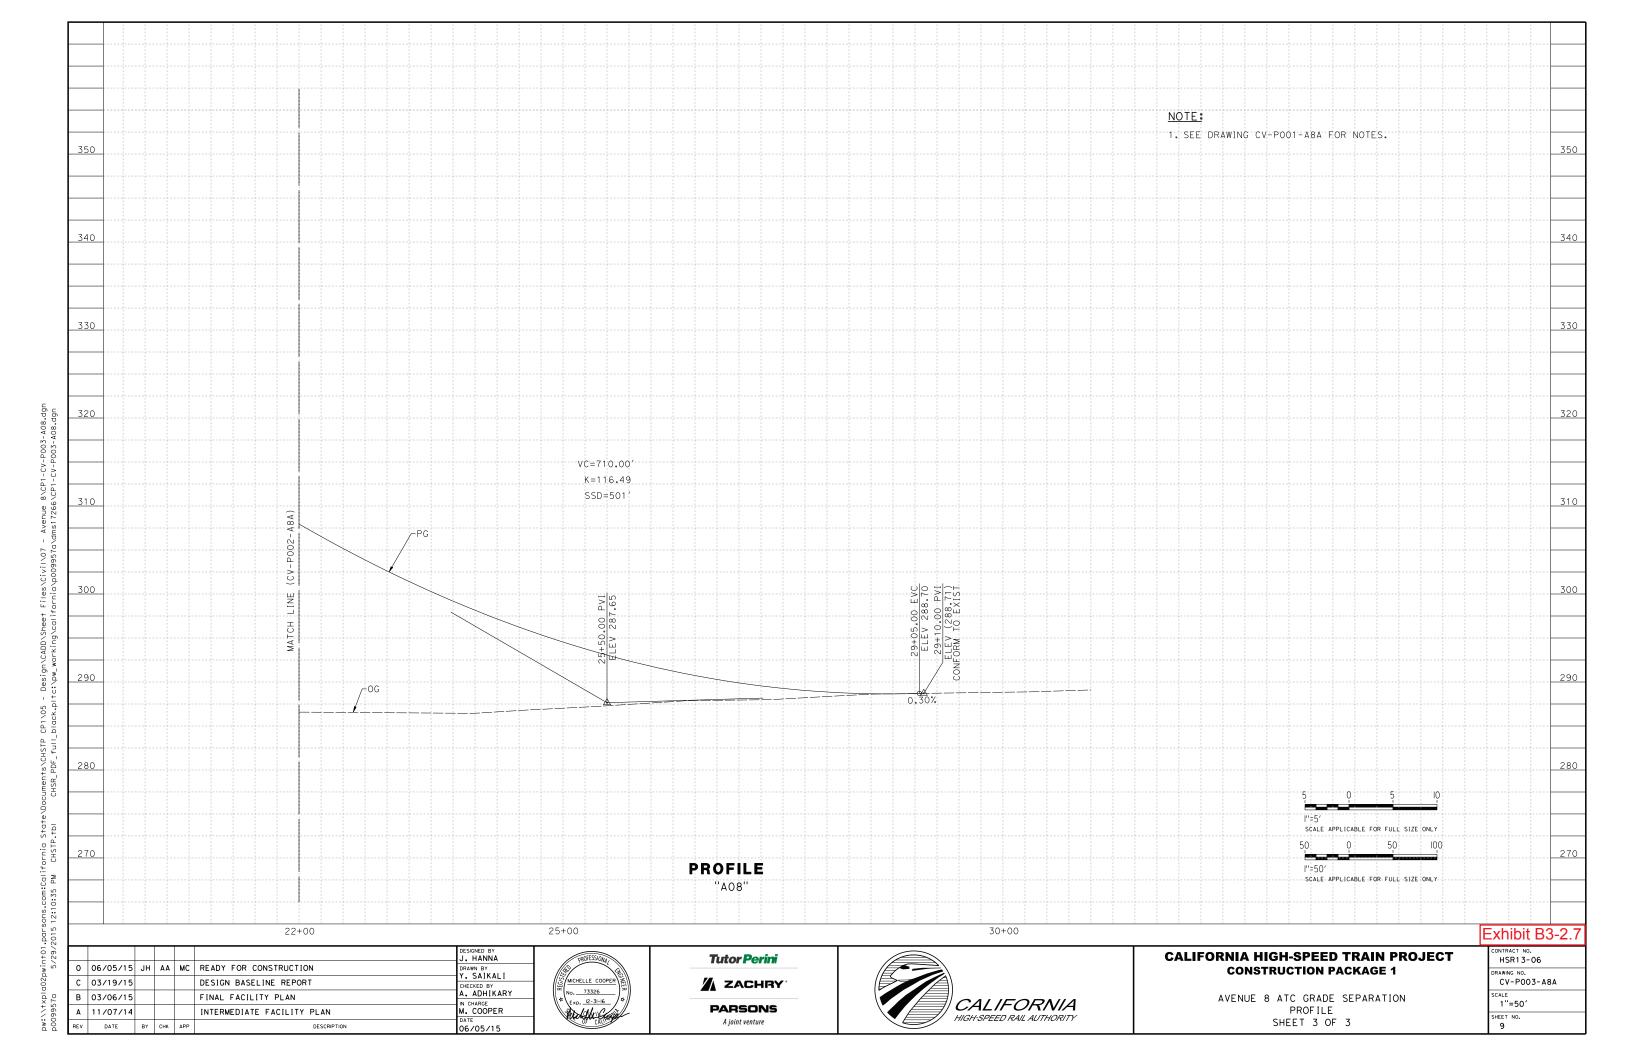

Project Drawings


Exhibit B3 – Roadway Drawings

Exhibit B3-3 - Avenue 9


O.4' HMA-TYPE A 0.35' Class 2 AB


3 O.17' HMA-TYPE A

PAVEMENT SECTION APPLICABLE WHEN PAVEMENT SECTION APPLICABLE WHEN THE UPPER 4 FEET OF NEW EMBANKMENT MATERIALS (MEASURED FROM THE GRADING PLANE) POSSESS A MINIMUM R-VALUE OF 50 AND A PLASTICITY INDEX OF LESS THAN 12%. WHERE SUBGRADE DOES NOT MEET THESE REQUIREMENTS, SEE GEOTECHNICAL ENGINEERING DESIGN REPORT AVE 9 OVERHEAD (NEW) FOR RECOMMENDATIONS.

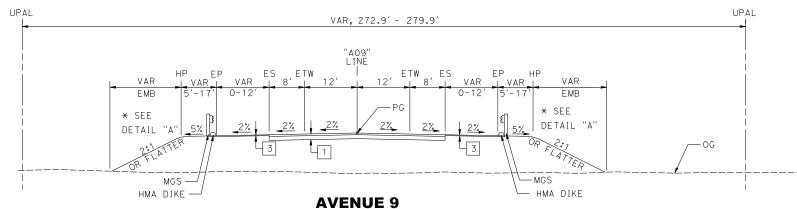


STA. 25+24.43 TO STA. 27+52.83

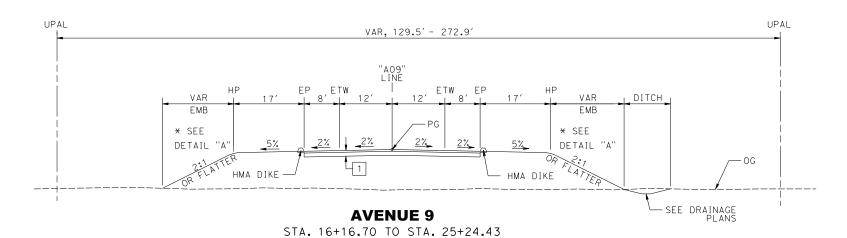

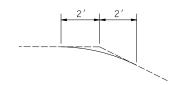

DETAIL "A" SLOPE ROUNDING

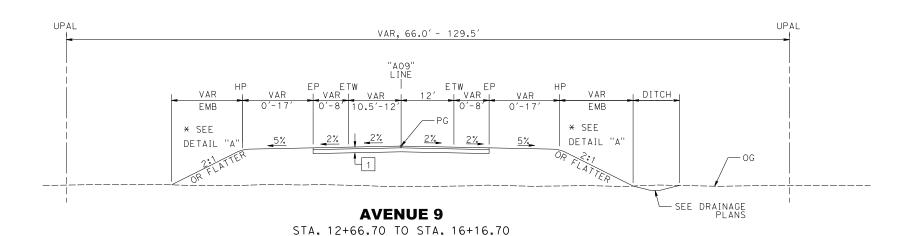

CALIFORNIA HIGH-SPEED TRAIN PROJECT CONSTRUCTION PACKAGE 1

AVENUE 9 GRADE SEPARATION TYPICAL SECTIONS SHEET 1 OF 2

NOTES:

29+29.83.

SEE STRUCTURE DRAWINGS FOR TYPICAL SECTION STA. 27+52.83 TO STA.

FOR EXISTING PAVEMENT MILLING AND OVERLAY LOCATIONS, SEE LAYOUT PLANS.

SEE LAYOUT PLANS FOR MGS AND DIKE

EARTHWORK SHALL BE CONSTRUCTED IN ACCORDANCE WITH THE MADERA COUNTY CONSTRUCTION SPECIFICATIONS, COUNTY OF MADERA SPECIAL PROVISIONS AND THE CONSTRUCTION RECOMMENDATIONS PRESENTED IN THE AVENUE 9 GEOTECHNICAL ENGINEERING DESIGN REPORT

Exhibit B3-3.1

0 05/15/15 JH AA MC READY FOR CONSTRUCTION RAWN BY SAIKALI C 10/13/14 FINAL FACILITY PLAN HECKED BY B 06/27/14 INTERMEDIATE FACILITY PLAN M. COOPER DESIGN BASELINE REPORT A 06/23/14 DATE BY CHK APP



SIGNED BY





0 05/15/15 JH AA MC READY FOR CONSTRUCTION SAIKALI FINAL FACILITY PLAN C 10/13/14 HECKED BY B 06/27/14 INTERMEDIATE FACILITY PLAN M. COOPER A 06/23/14 DESIGN BASELINE REPORT DATE BY CHK APP







CONSTRUCTION PACKAGE 1


AVENUE 9 GRADE SEPARATION TYPICAL SECTIONS SHEET 2 OF 2

	FRACT NO. ISR13-06
	WING NO. CV-X002-A09
SCAL	E IO SCALE
SHEE	T NO.

NOTES:

- FOR SYMBOLS, ABBREVIATIONS, & LEGEND 7. SEE CALTRANS STD PLANS A10A TO A10H.
- 2. FOR HOT MIX ASPHALT DIKE DETAILS, SEE CALTRANS STD PLAN A87B & A77N4.
- FOR MIDWEST GUARDRAIL SYSTEM DETAILS, SEE CALTRANS STD PLAN A77P2 & A77N4.
- FOR MGS RAILING CONNECTION DETAILS TO BRIDGE RAILING, SEE CALTRANS STD PLAN A77U1, A77U2 & A77U4.

- FOR DRAINAGE DETAILS, SEE DRAWINGS CV-D001-A09 TO CV-D003-A09, & CV-DD001-A09 TO CV-DP001-A09.
- FOR PAVEMENT DELINEATION & SIGNING DETAILS, SEE DRAWINGS CV-PD001-A09 TO CV-PD003-A09. 8.
- 9. FOR STRUCTURE DETAILS, SEE DRAWING ST-K1100-A09.
- 10. HST/MADERA COUNTY ROW TBD BASED ON FINAL AGREEMENT BETWEEN THE AUTHORITY AND MADERA COUNTY.

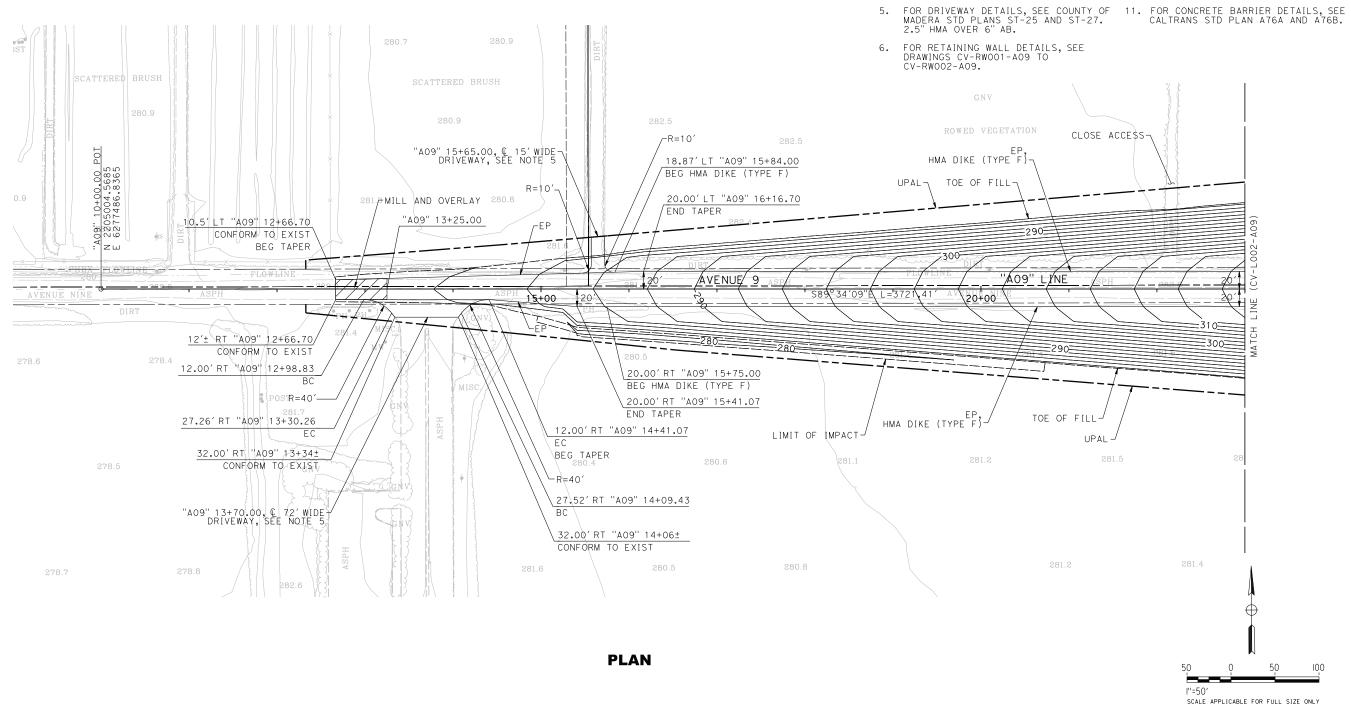

SIGNED BY 0 05/15/15 JH AA MC READY FOR CONSTRUCTION RAWN BY SAIKALI C 10/13/14 FINAL FACILITY PLAN HECKED BY B 06/27/14 INTERMEDIATE FACILITY PLAN M. COOPER DESIGN BASELINE REPORT A 06/23/14

DATE BY CHK APP



Tutor Perini ZACHRY **PARSONS** A joint venture




CALIFORNIA HIGH-SPEED TRAIN PROJECT CONSTRUCTION PACKAGE 1

AVENUE 9 GRADE SEPARATION LAYOUT SHEET 1 OF 3

xhibit B3-3.
CONTRACT NO. HSR13-06
DRAWING NO. CV-L001-A09
1"=50'
SHEET NO.

1. SEE DRAWING CV-LOO1-A09 FOR NOTES.

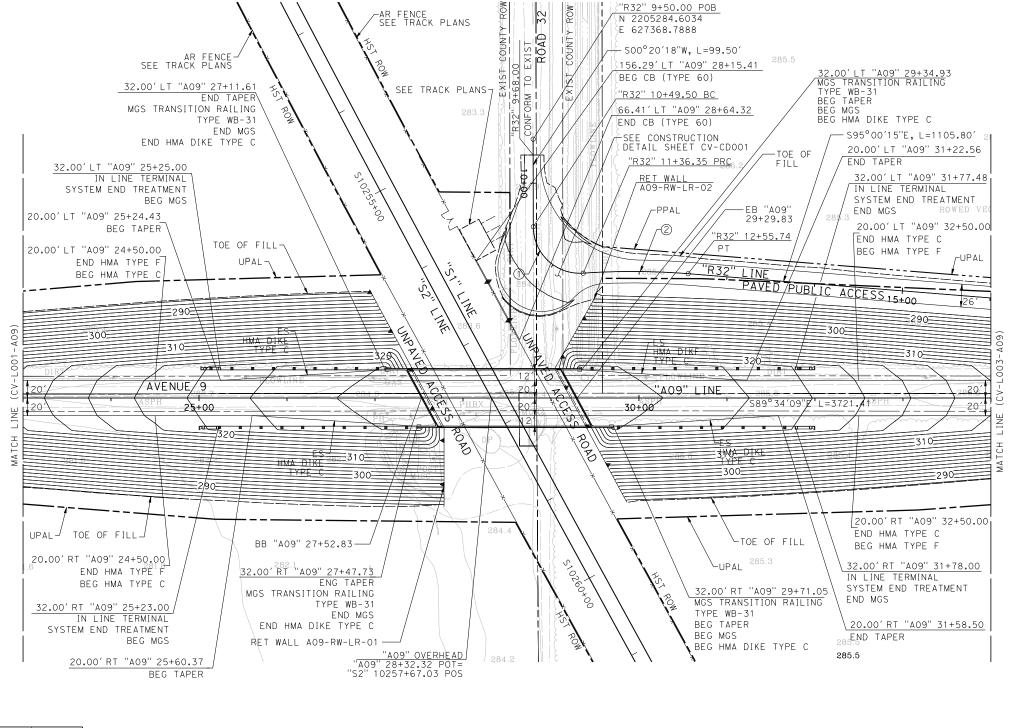

CI	JR'	۷E	DΑ	TΑ

NO.	R	Δ	Τ	L
1	53.00′	03°53′06''	56.72′	86.85′
2	800.00′	81°26′56"	59.81′	119.39

PLAN

50 0 50 100 I''=50' SCALE APPLICABLE FOR FULL SIZE ONLY

EX	hıl	hii	tΒ	13-	З4
		~ 1		_	Ο.

7							J. HANNA
Ŋ,	0	05/15/15	JH	AA	мс	READY FOR CONSTRUCTION	DRAWN BY
	С	10/13/14				FINAL FACILITY PLAN	Y. SAIKALI CHECKED BY
97	В	06/27/14				INTERMEDIATE FACILITY PLAN	A. ADHIKARY
10497	Α	06/23/14					M. COOPER
00d	REV	DATE	BY	СНК	APP	DESCRIPTION	DATE 05/15/15








CALIFORNIA HIGH-SPEED TRAIN PROJECT CONSTRUCTION PACKAGE 1

AVENUE 9 GRADE SEPARATION LAYOUT SHEET 2 OF 3

MINDIC DO C.
CONTRACT NO. HSR13-06
DRAWING NO. CV-L002-A09
1"=50'
SHEET NO.

1. SEE DRAWING CV-LOO1-A09 FOR NOTES.

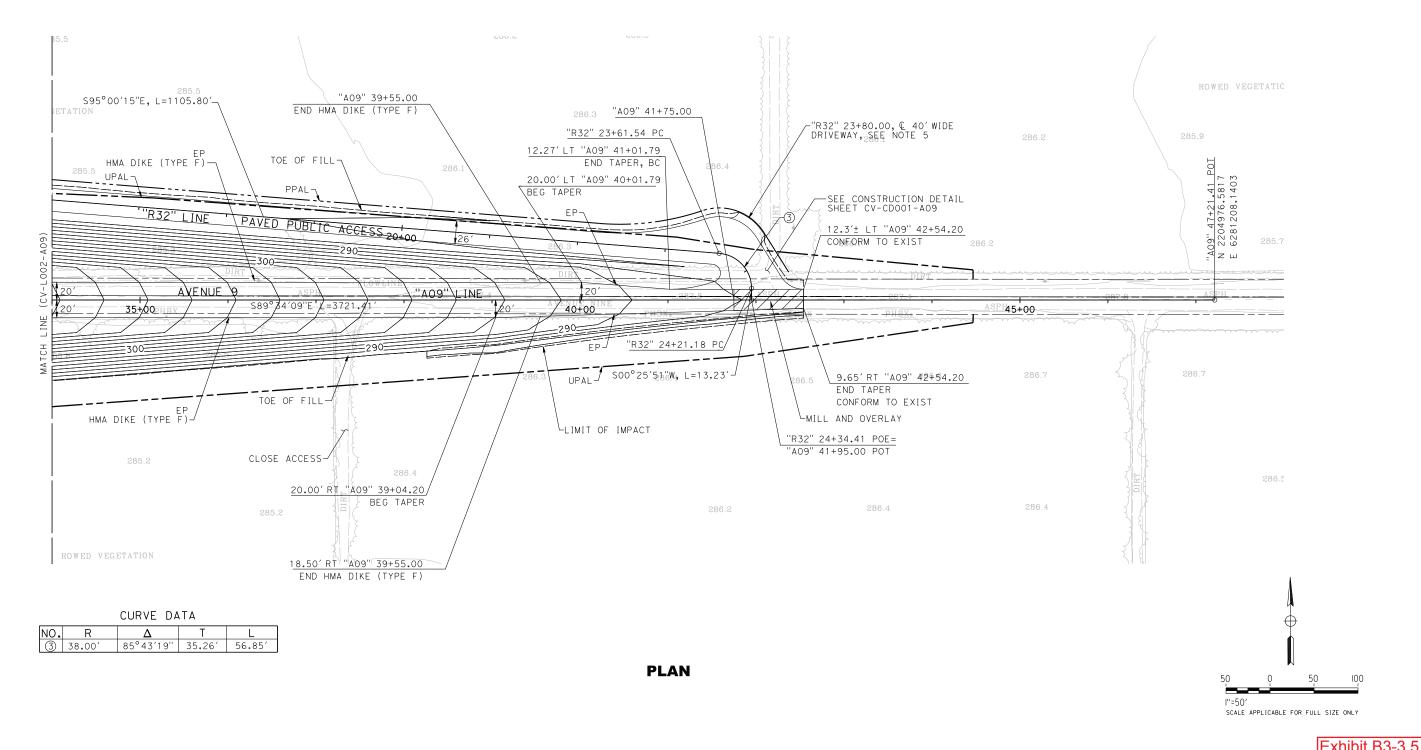



Tutor Perini

ZACHRY


PARSONS
A joint venture





CALIFORNIA HIGH-SPEED TRAIN PROJECT CONSTRUCTION PACKAGE 1

AVENUE 9 GRADE SEPARATION LAYOUT SHEET 3 OF 3

	XIIIDIL B3-3.0
	CONTRACT NO. HSR13-06
	DRAWING NO. CV-L003-A09
	1"=50'
	SHEET NO. 7

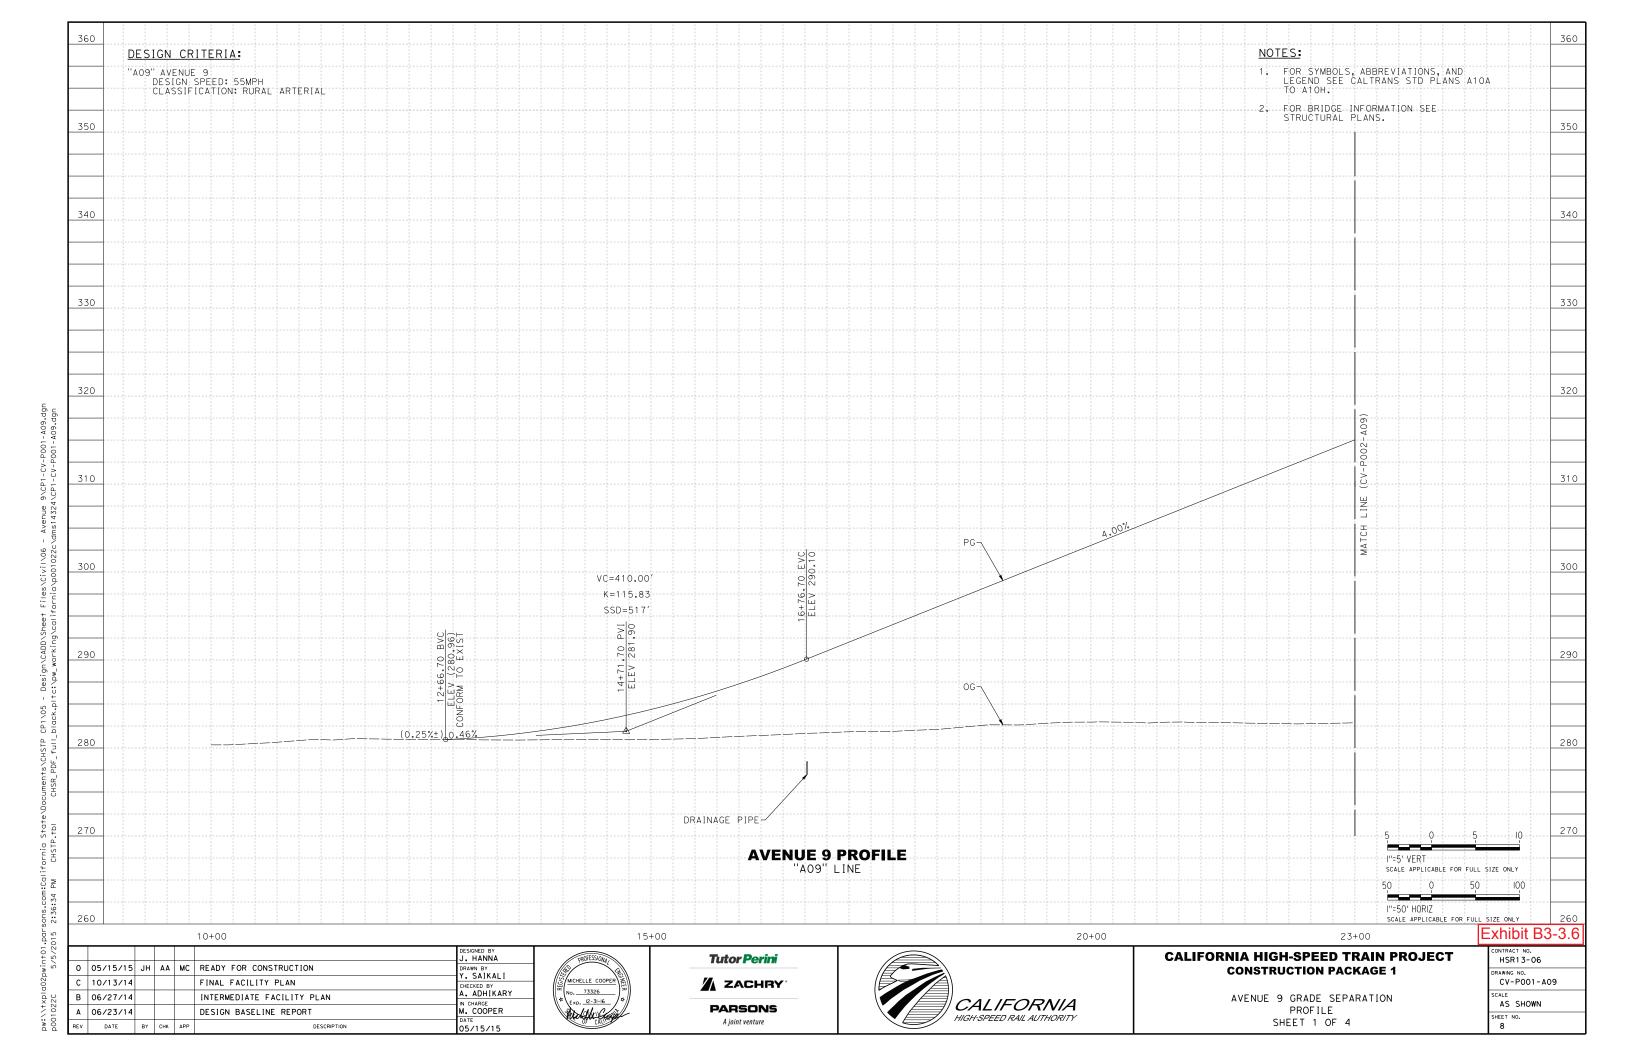

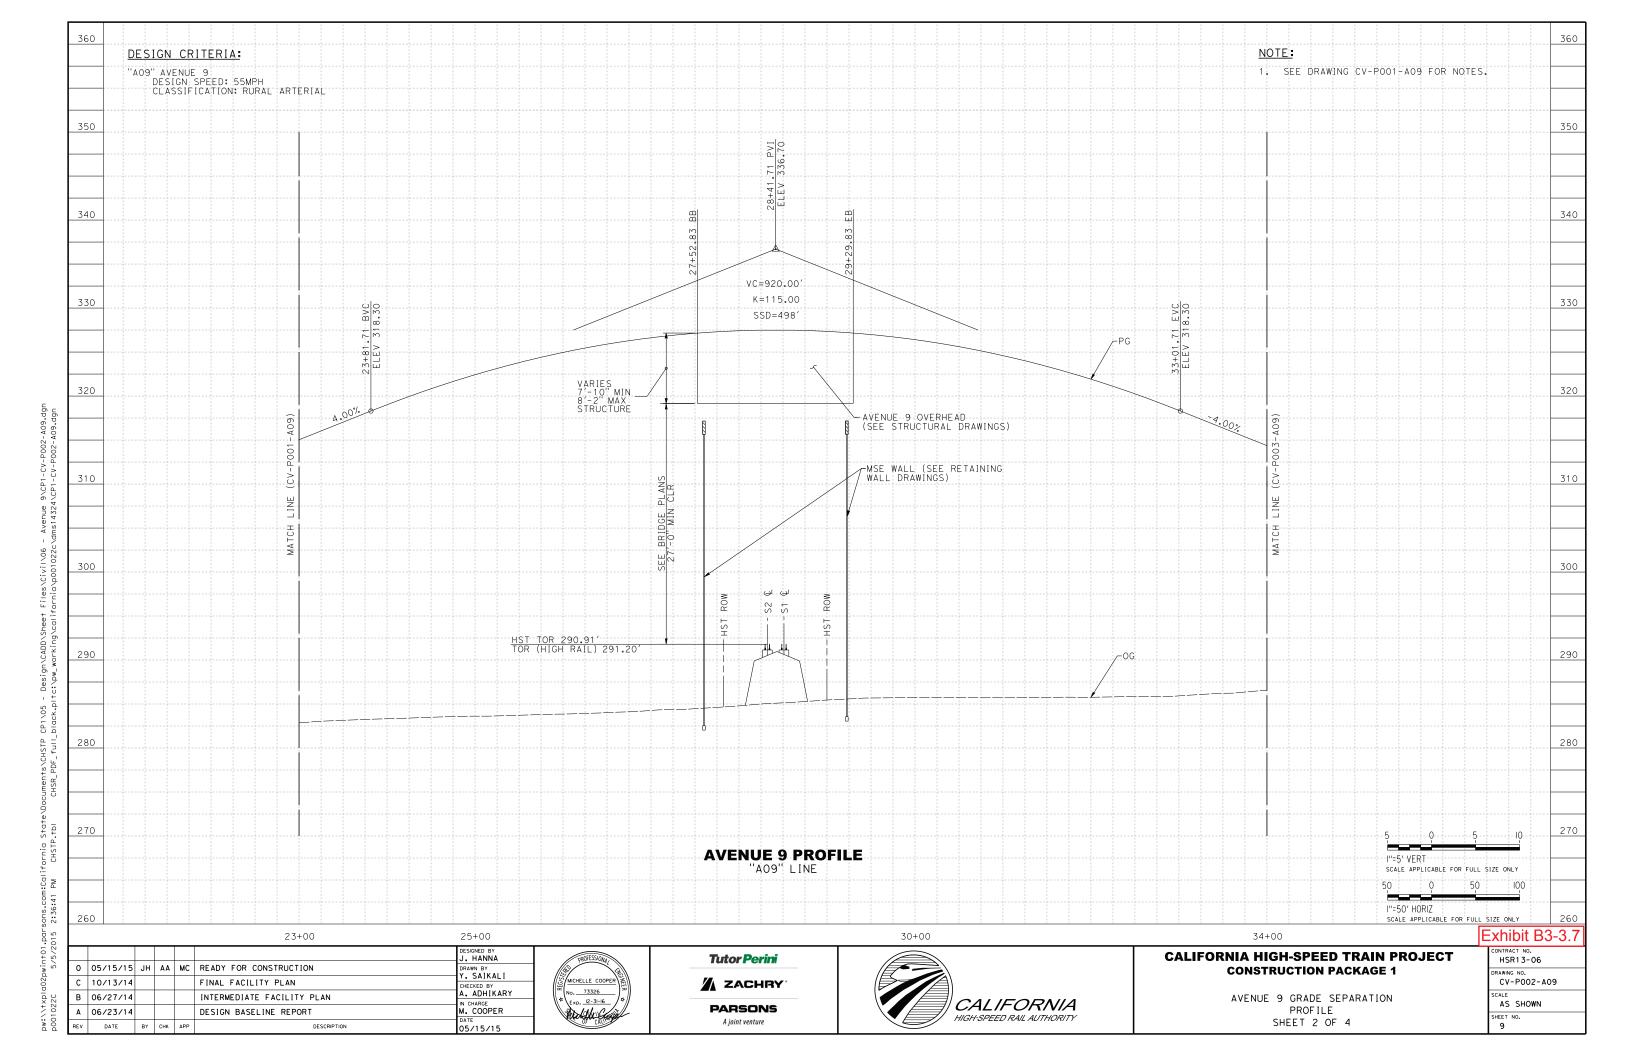

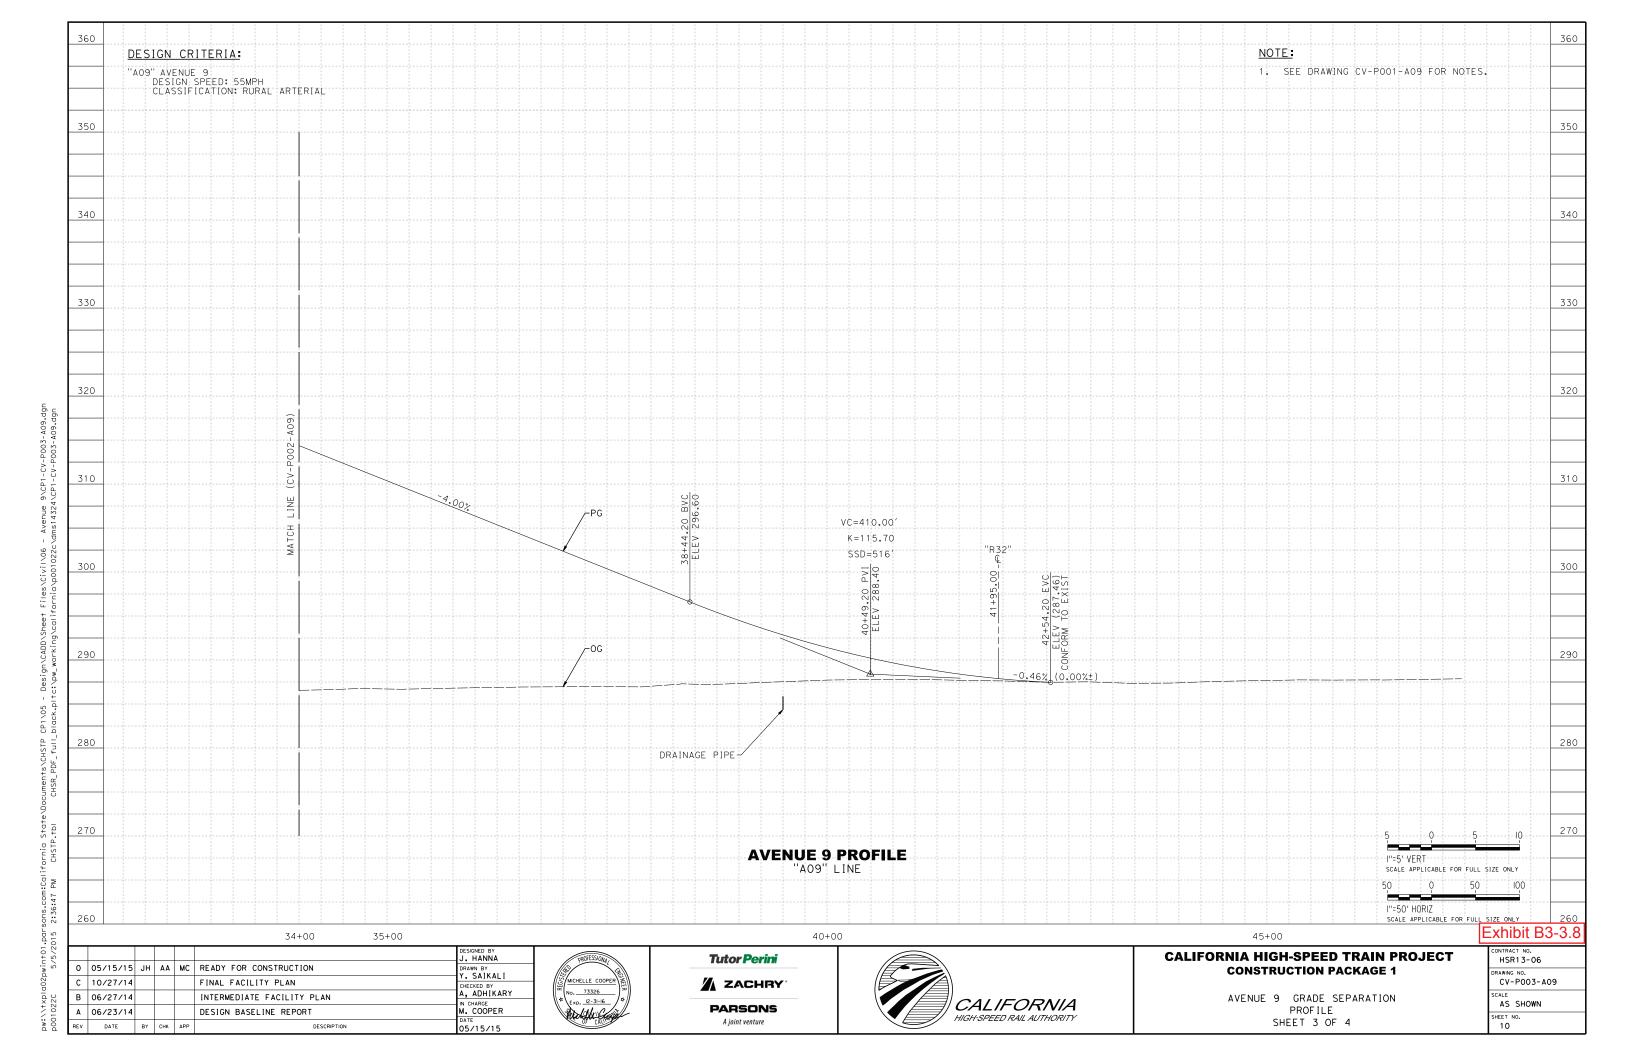


Project Drawings


Exhibit B3 – Roadway Drawings


Exhibit B3-4 - Avenue 10

0.25' HMA-A 0.35' CLASS 2 AB

PAVEMENT SECTION APPLICABLE WHEN THE UPPER 4 FEET OF NEW EMBANKMENT MATERIALS (MEASURED FROM THE GRADING PLANE) POSSESS A MINIMUM R-VALUE OF 50 AND A PLASTICITY INDEX OF LESS THAN 12%. WHERE SUBGRADE DOES NOT MEET THESE REQUIREMENTS, SEE GEOTECHNICAL ENGINEERING DESIGN REPORT AVE 10 OVERHEAD (NEW) FOR RECOMMENDATIONS.

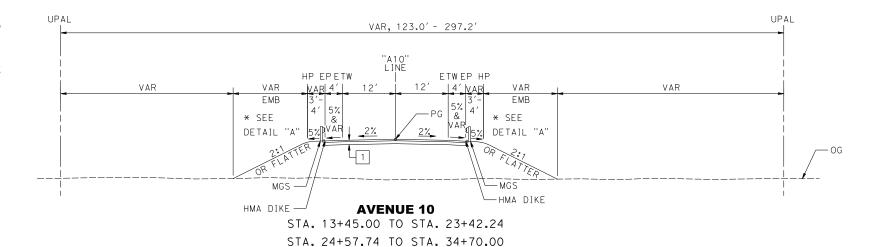


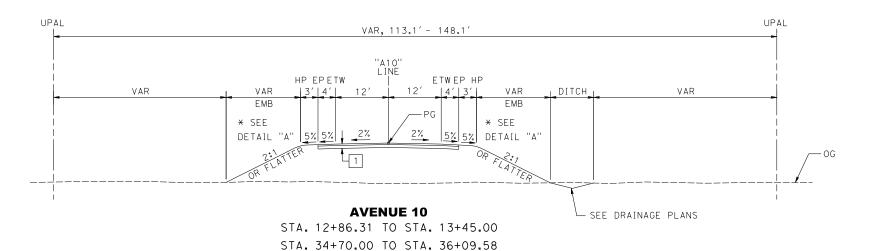

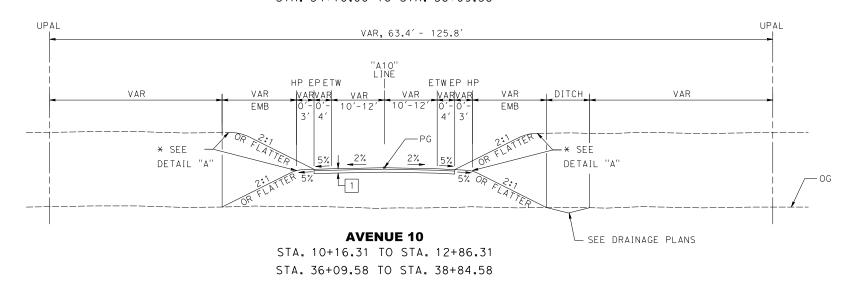

NOTES:

- 1. SEE DRAWING ST-K1100-A10 FOR TYPICAL SECTION STA. 23+42.24 TO STA. 24+57.74
- 2. FOR EXISTING PAVEMENT MILLING AND OVERLAY LOCATIONS, SEE LAYOUT PLANS
- 3. FOR SHOULDER SLOPE TRANSITION AT BRIDGE APPROACHES, SEE CV-CD001-A10
- 4. SEE LAYOUT PLANS FOR MGS AND DIKE LIMITS
- 5. EARTHWORK SHALL BE CONSTRUCTED IN ACCORDANCE WITH THE MADERA COUNTY CONSTRUCTION SPECIFICATIONS, COUNTY OF MADERA SPECIAL PROVISIONS AND THE CONSTRUCTION RECOMMENDATIONS PRESENTED IN THE AVENUE 10 GEOTECHNICAL ENGINEERING DESIGN REPORT

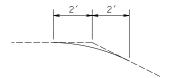

DETAIL "A" SLOPE ROUNDING

Exhibit B3-4.1







CALIFORNIA HIGH-SPEED TRAIN PROJECT CONSTRUCTION PACKAGE 1

AVENUE 10 GRADE SEPARATION
TYPICAL SECTIONS

NTRACT NO. HSR13-06	
CV-X001-A10	
NO SCALE	
HEET NO.	


DESIGN CRITERIA:

"A10" AVENUE 10 DESIGN SPEED: 55MPH CLASSIFICATION: RURAL LOCAL

NOTES:

- FOR SYMBOLS, ABBREVIATIONS, & LEGEND SEE CALTRANS STD PLANS A10A TO A10H.
- 2. FOR HOT MIX ASPHALT DIKE DETAILS, SEE CALTRANS STD PLAN A87B & A77N4.
- 3. FOR MIDWEST GUARDRAIL SYSTEM (MGS)
 DETAILS, SEE CALTRANS STD PLAN
 A77P2 & A77N4.
- 4. FOR MGS TRANSITION RAILING AND CONNECTION DETAILS TO BRIDGE RAILING, SEE CALTRANS STD PLAN A77U1, A77U2. AND A77U4.
- 5. FOR DRIVEWAY DETAILS, SEE COUNTY OF MADERA STD PLANS ST-25 & ST-27. 2.5" HMA OVER 6" AB.

- 6. FOR RETAINING WALL DETAILS, SEE DRAWINGS CV-RW001-A10 TO CV-RW002-A10.
- 7. FOR DRAINAGE DETAILS, SEE DRAWINGS CV-D001-A10 TO CV-D003-A10, CV-DD001-A10 & CV-DP001-A10.
- FOR PAVEMENT DELINEATION & SIGNING DETAILS, SEE DRAWINGS CV-PD001-A10 TO CV-PD003-A10.
- 9. FOR STRUCTURE DETAILS, SEE DRAWING ST-K1100-A10.
- 10. HST/MADERA COUNTY ROW TBD BASED ON FINAL AGREEMENT BETWEEN THE AUTHORITY AND MADERA COUNTY.

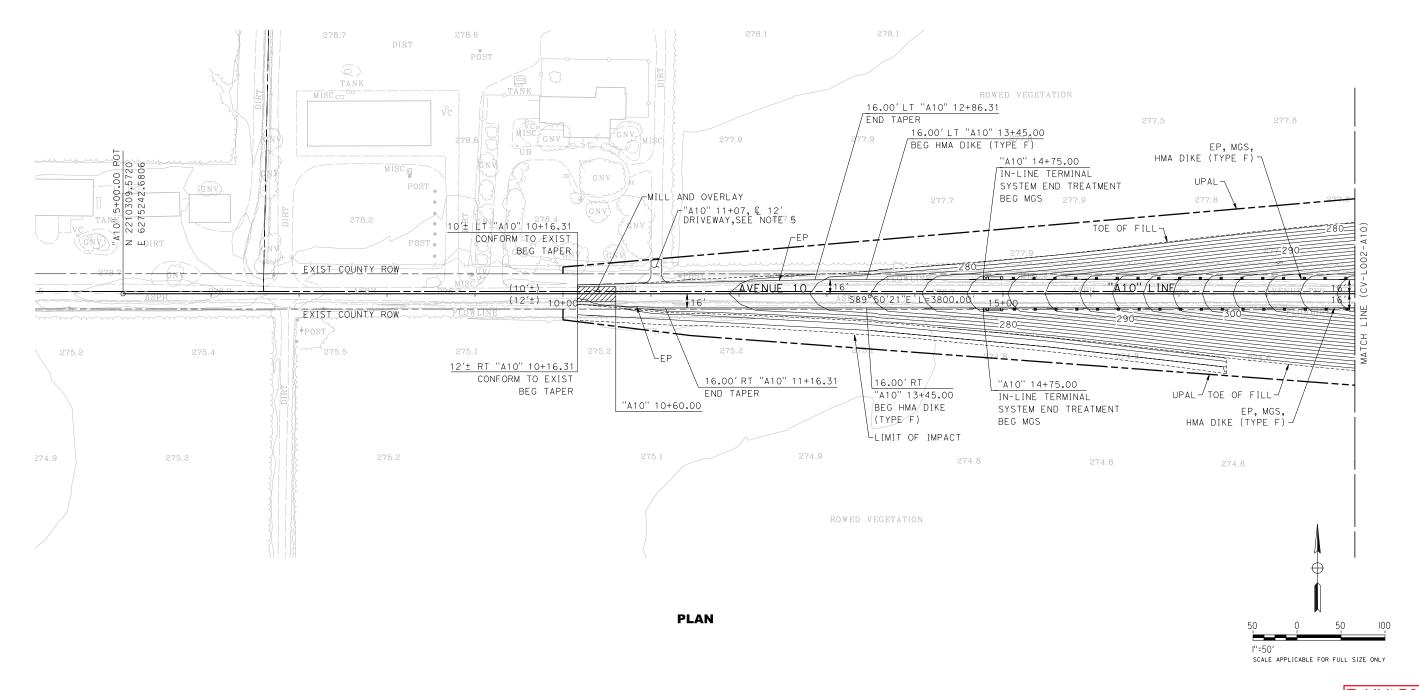

| DESIGNED BY | J. HANNA | D. HAN



Tutor Perini

ZACHRY

PARSONS

A joint venture




CALIFORNIA HIGH-SPEED TRAIN PROJECT CONSTRUCTION PACKAGE 1

AVENUE 10 GRADE SEPARATION
LAYOUT
SHEET 1 OF 3

xhibit B3-4.2
CONTRACT NO. HSR13-06
DRAWING NO. CV-LOO1-A10
1"=50'
SHEET NO.

1. SEE DRAWING CV-LOO1-A10 FOR NOTES.

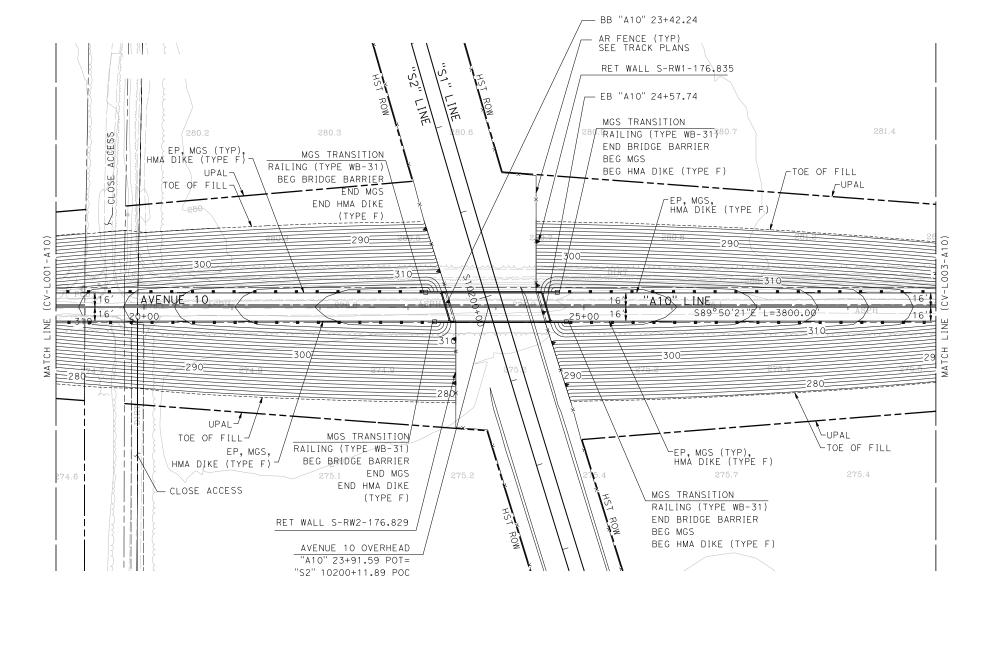

50 0 50 100

I'=50'
SCALE APPLICABLE FOR FULL SIZE ONLY

PLAN

						DESIGNED BY J. HANNA
0	05/08/15	JH	AA	мс	READY FOR CONSTRUCTION	DRAWN BY Y. SAIKALI
С	11/20/14				FINAL FACILITY PLAN	CHECKED BY
В	07/23/14				INTERMEDIATE FACILITY PLAN	A. ADHIKARY
Α	06/23/14				DESIGN BASELINE REPORT	IN CHARGE M. COOPER
REV	DATE	ВҮ	СНК	APP	DESCRIPTION	DATE 05/08/15







CALIFORNIA HIGH-SPEED TRAIN PROJECT CONSTRUCTION PACKAGE 1

AVENUE 10 GRADE SEPARATION LAYOUT SHEET 2 OF 3

Ε	xhibit B3-4.3
	CONTRACT NO. HSR13-06
	DRAWING NO. CV-LOO2-A10
	1"=50'
	SHEET NO. 5

1. SEE DRAWING CV-LOO1-A10 FOR NOTES.

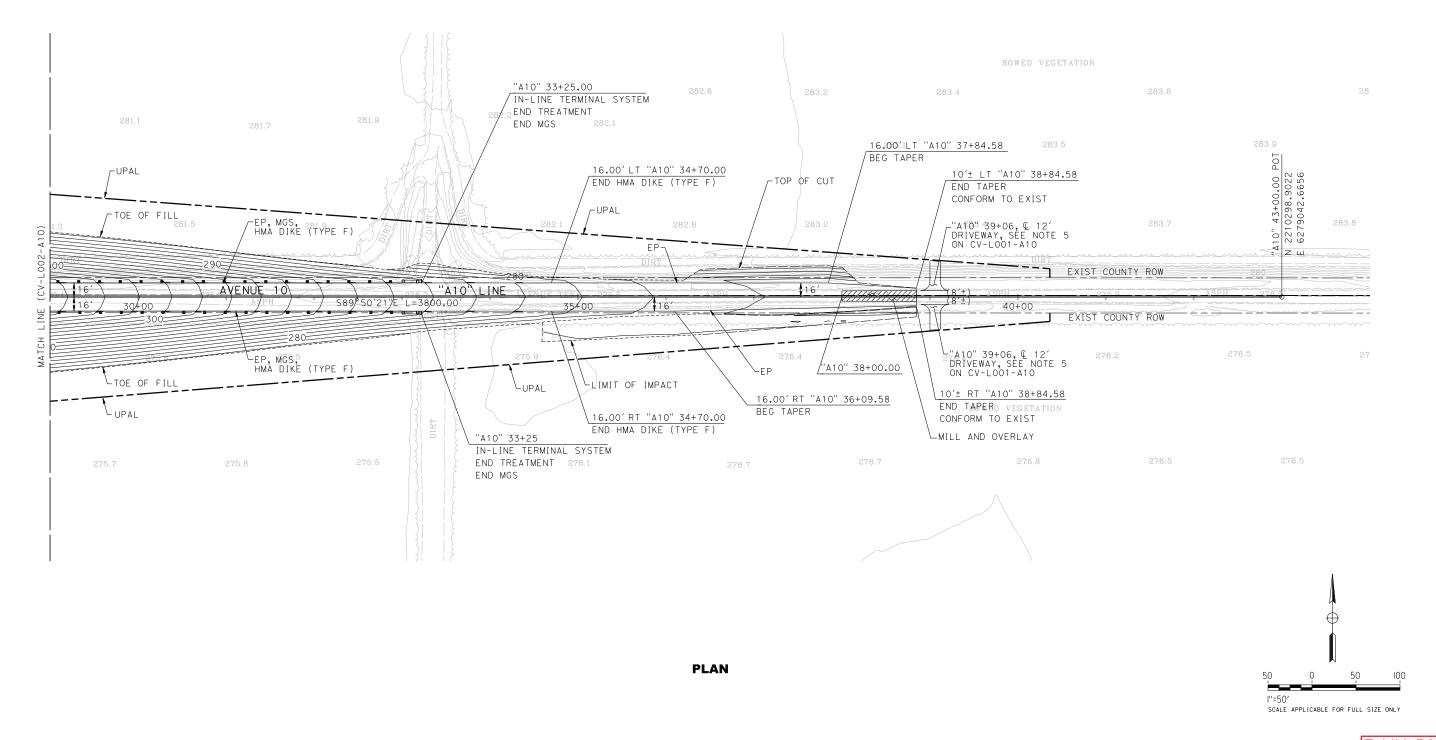


Exhibit B3-4.4

,							J. HANNA	ı
2	0	05/08/15	JH	AA	мс	READY FOR CONSTRUCTION	DRAWN BY Y. SAIKALI	ı
	С	11/20/14				FINAL FACILITY PLAN	CHECKED BY	ı
97	В	07/23/14				INTERMEDIATE FACILITY PLAN	A. ADHIKARY	ı
104	Α	06/23/14				DESIGN BASELINE REPORT	M. COOPER	1
p001	REV	DATE	BY	СНК	APP	DESCRIPTION	05/08/15	










CALIFORNIA HIGH-SPEED TRAIN PROJECT CONSTRUCTION PACKAGE 1

AVENUE 10 GRADE SEPARATION LAYOUT SHEET 3 OF 3

ZITIDIL DO-4.4					
CONTRACT NO. HSR13-06					
DRAWING NO. CV-L003-A10					
1"=50'					
SHEET NO.					

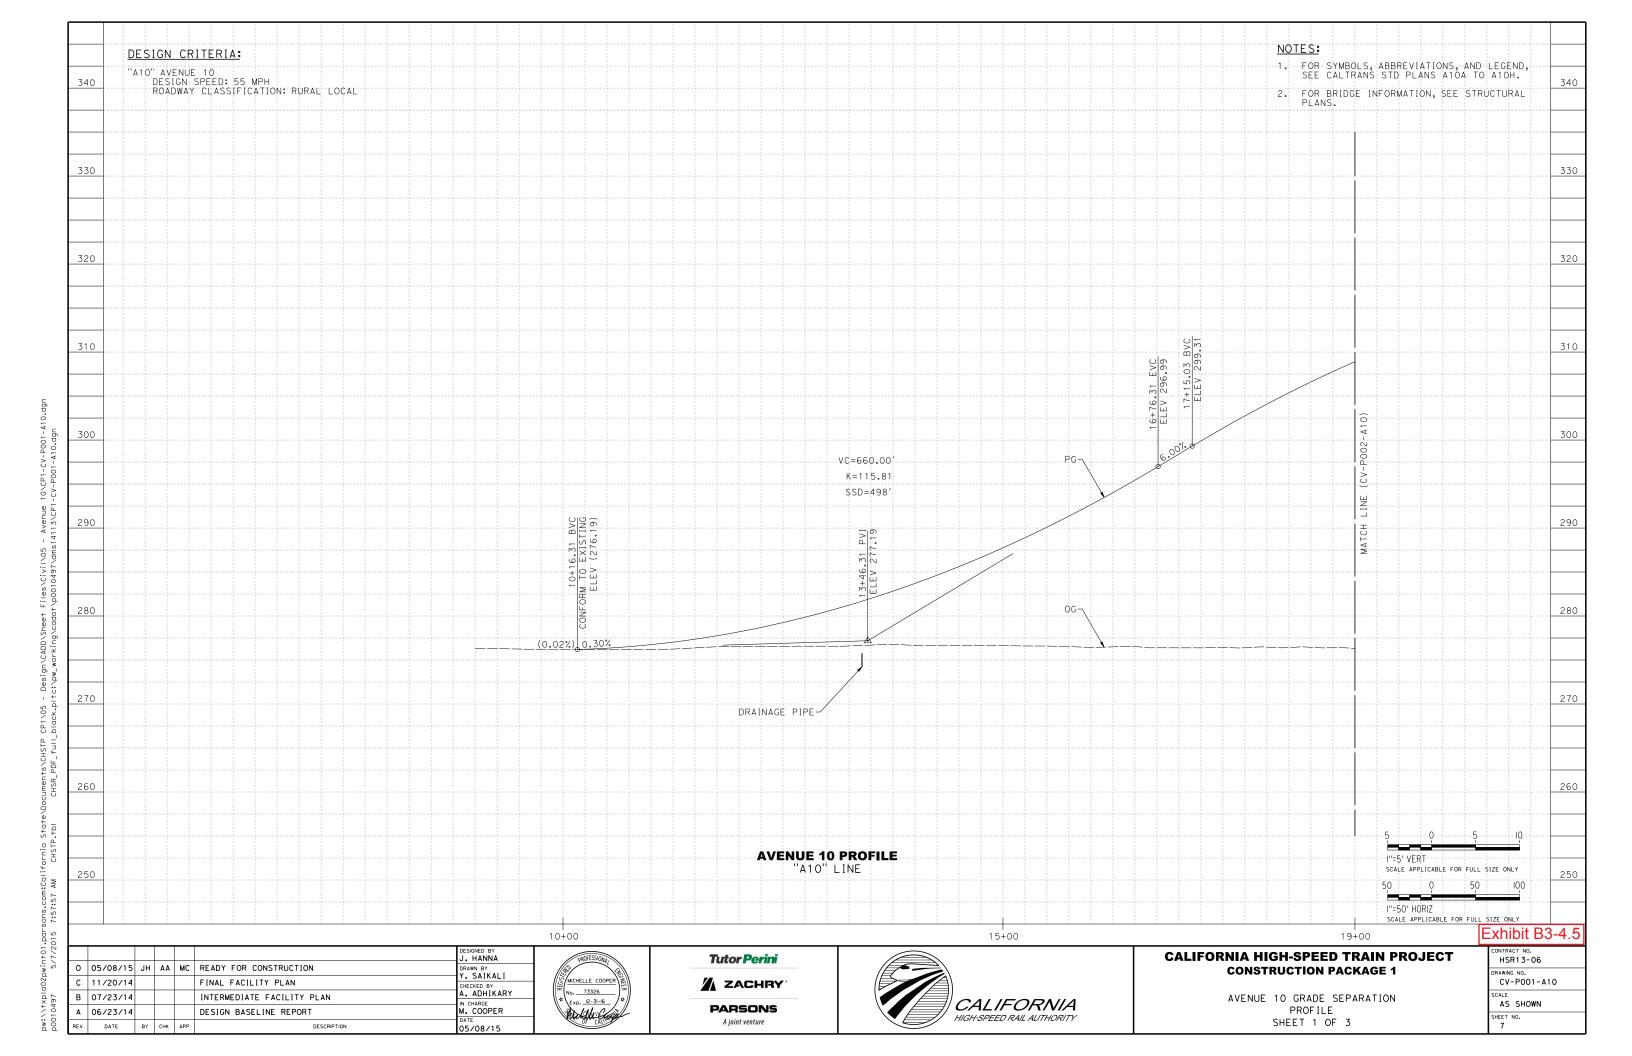

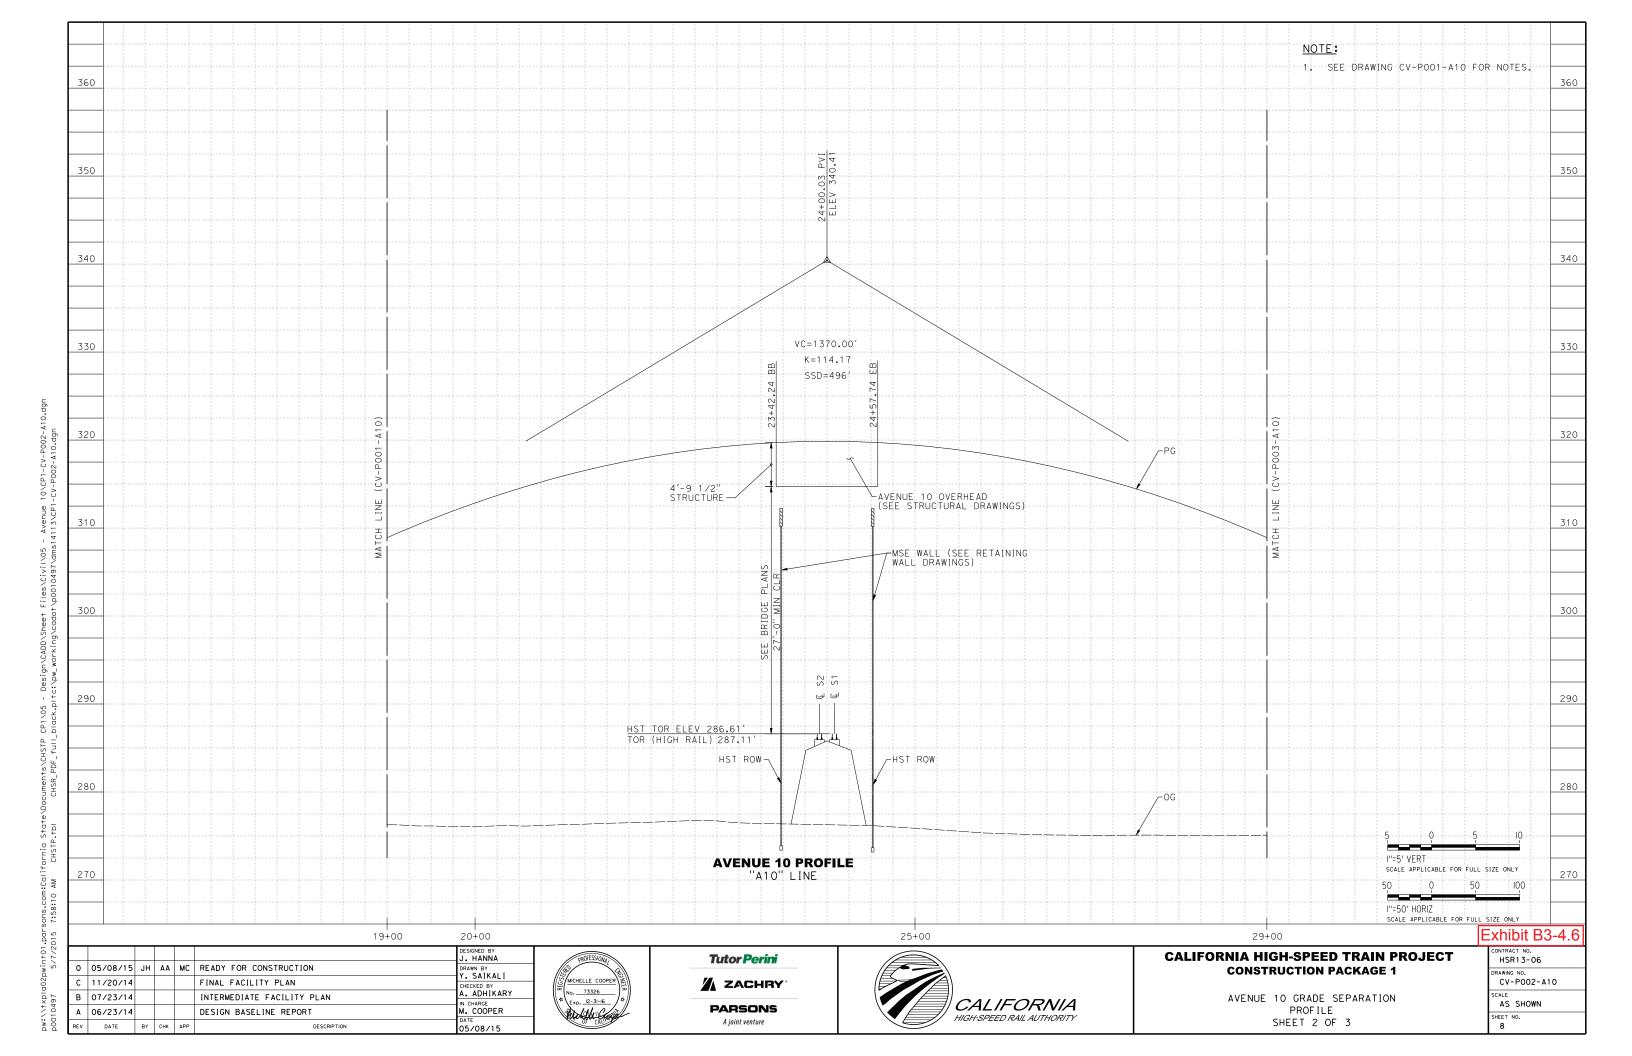

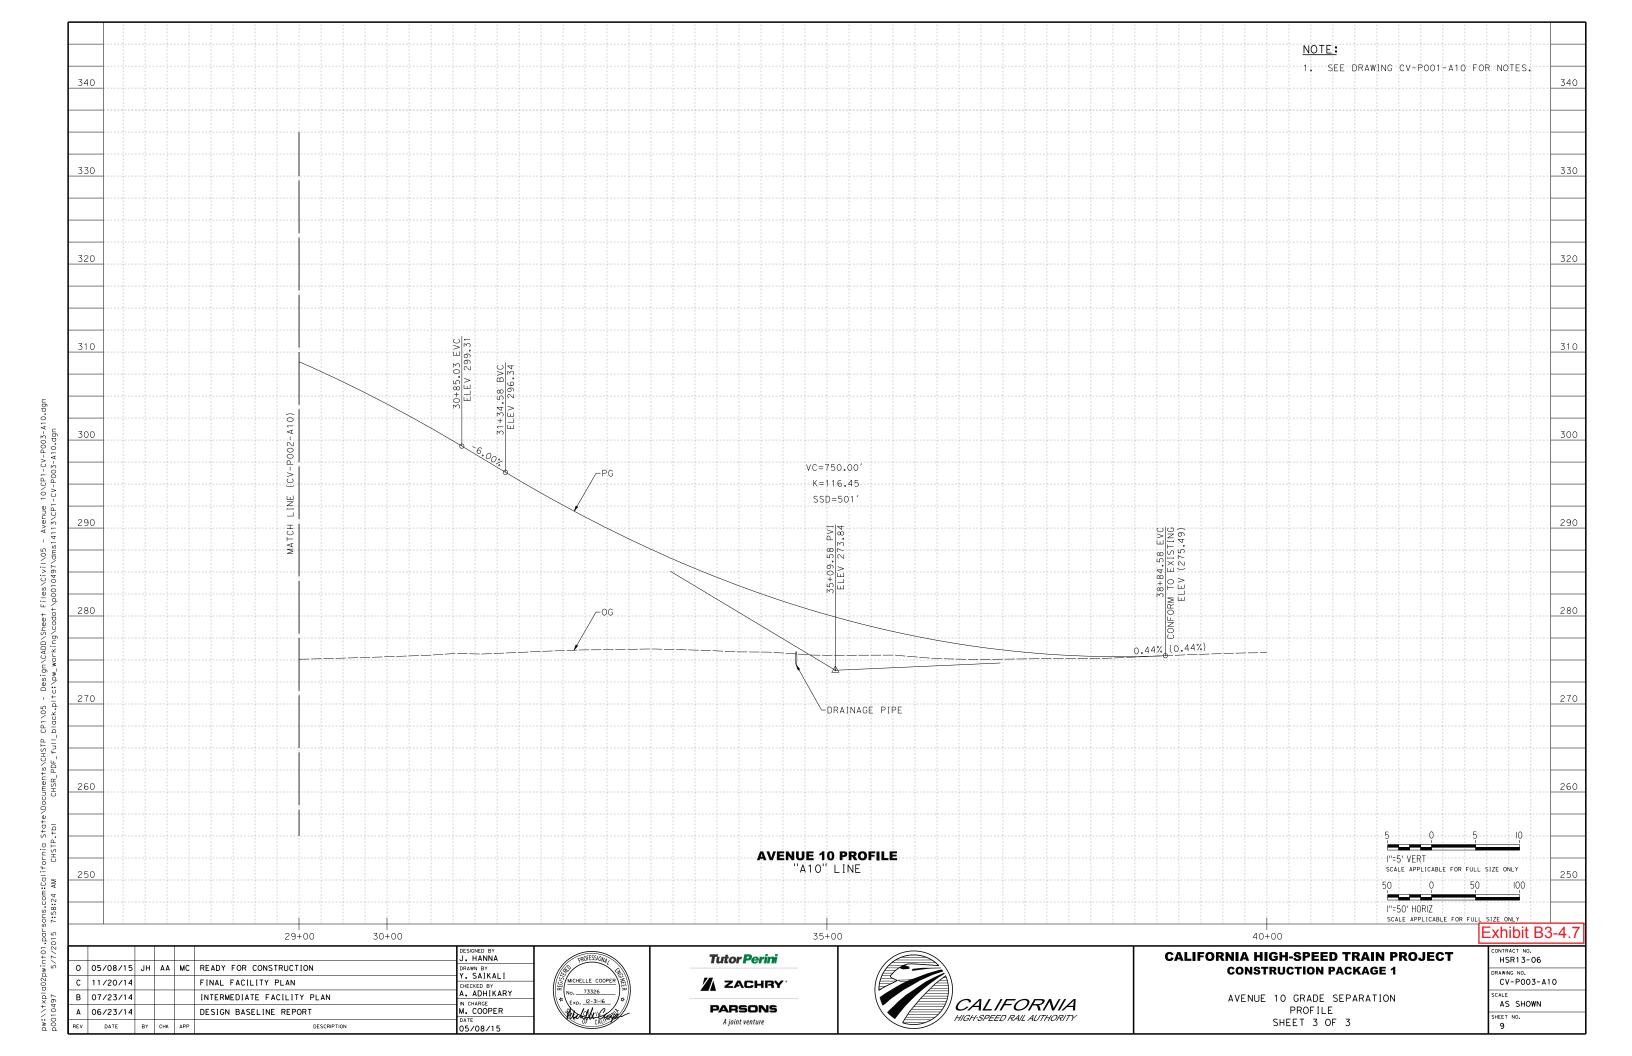


Project Drawings

Exhibit B3 – Roadway Drawings


Exhibit B3-5 - Avenue 11


PAVEMENT SECTION APPLICABLE WHEN THE UPPER 4 FEET OF NEW EMBANKMENT MATERIALS (MEASURED FROM THE GRADING PLANE) POSSESS A MINIMUM R-VALUE OF 50 AND A PLASTICITY INDEX OF LESS THAN 12%. WHERE SUBGRADE DOES NOT MEET THESE REQUIREMENTS, SEE GEOTECHNICAL ENGINEERING DESIGN REPORT AVE 11 OVERHEAD (NEW) FOR RECOMMENDATIONS.

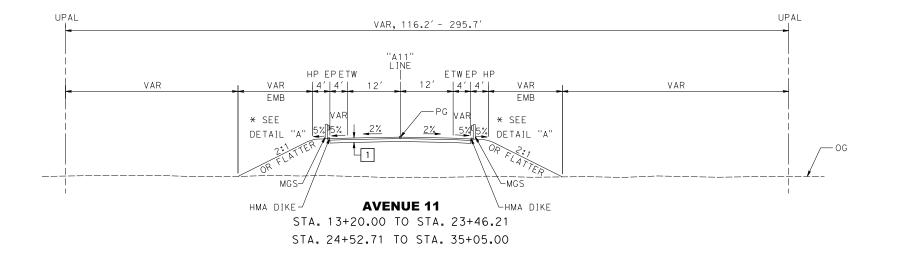

NOTES:

- 1. SEE DRAWING ST-K1100-A11 FOR TYPICAL SECTION STA. 23+46.21 TO STA. 24+52.71
- 2. FOR EXISTING PAVEMENT MILLING AND OVERLAY LOCATIONS, SEE LAYOUT PLANS
 - 3. FOR SHOULDER SLOPE TRANSITION AT BRIDGE APPROACHES, SEE CV-CD001-A11
 - 4. SEE LAYOUT PLANS FOR MGS AND DIKE LIMITS
- 5. EARTHWORK SHALL BE CONSTRUCTED IN ACCORDANCE WITH THE MADERA COUNTY CONSTRUCTION SPECIFICATIONS, COUNTY OF MADERA SPECIAL PROVISIONS AND THE CONSTRUCTION RECOMMENDATIONS PRESENTED IN THE AVENUE 11 GEOTECHNICAL ENGINEERING DESIGN REPORT

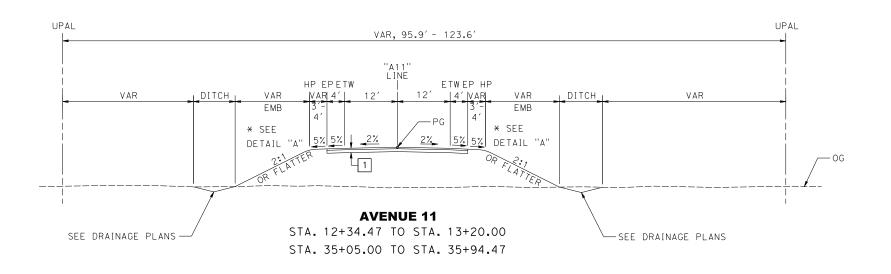

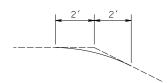

DETAIL "A" SLOPE ROUNDING

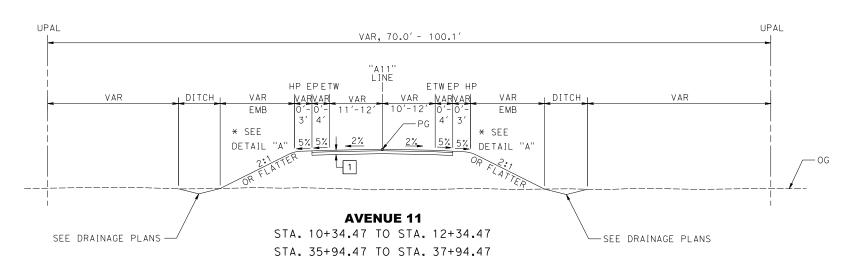


Exhibit B3-5.1

						J. HANNA
						DRAWN BY Y. SAIKALI
0	05/08/15	JH	AA	мс	READY FOR CONSTRUCTION	CHECKED BY
В	11/20/14				FINAL FACILITY PLAN	A. ADHIKARY IN CHARGE
Α	07/23/14				INTERMEDIATE FACILITY PLAN	M. COOPER
REV	DATE	ВҮ	СНК	APP	DESCRIPTION	05/08/2015







CALIFORNIA HIGH-SPEED TRAIN PROJECT CONSTRUCTION PACKAGE 1

AVENUE 11 GRADE SEPARATION
TYPICAL SECTIONS

ONTRACT NO.	
HSR13-06	
RAWING NO.	
CV-X001-A11	
CALE	
NO SCALE	
HEET NO.	
3	

2. FOR HOT MIX ASPHALT DIKE DETAILS, SEE CALTRANS STD PLAN A87B AND

FOR MIDWEST GUARDRAIL SYSTEM DETAILS, SEE CALTRANS STD PLAN A77P2 AND A77N4.

FOR MGS TRANSITION RAILING AND CONNECTION DETAILS TO BRIDGE RAILING, SEE CALTRANS STD PLAN A77U1, A77U2, AND A77U4.


FOR RETAINING WALL DETAILS, SEE DRAWINGS CV-RW001-A11 TO CV-RW002-A11.
 FOR DRAINAGE DETAILS, SEE DRAWING

7. FOR DRAINAGE DETAILS, SEE DRAWINGS CV-D001-A11 TO CV-D003-A11, CV-DD001-A11 & CV-DP001-A11.

B. FOR PAVEMENT DELINEATION & SIGNING DETAILS, SEE DRAWINGS CV-PD001-A11 TO CV-PD003-A11.

9. FOR STRUCTURE DETAILS, SEE DRAWING ST-K1100-A11.

10. HST/MADERA COUNTY ROW TBD BASED ON FINAL AGREEMENT BETWEEN THE

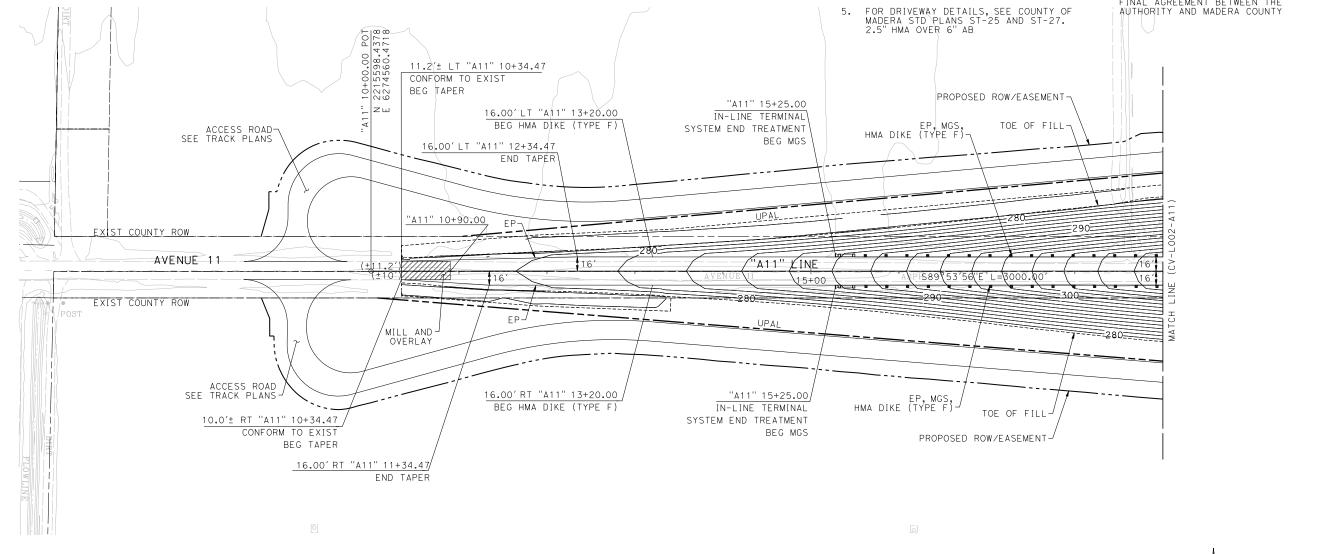

							J. HANNA
١.	0	05/08/15	JH	AA	мс	READY FOR CONSTRUCTION	DRAWN BY
	С	11/20/14				FINAL FACILITY PLAN	Y. SAIKALI CHECKED BY
	В	7/23/14				INTERMEDIATE FACILITY PLAN	A. ADHIKARY IN CHARGE
	Α	06/23/14				DESIGN BASELINE REPORT	M. COOPER
	REV	DATE	BY	СНК	APP	DESCRIPTION	DATE 05/08/2015





PLAN



CALIFORNIA HIGH-SPEED TRAIN PROJECT CONSTRUCTION PACKAGE 1

AVENUE 11 GRADE SEPARATION LAYOUT SHEET 1 OF 3

(nibit B3-5.2
DNTRACT NO. HSR13-06
RAWING NO. CV-L001-A11
1"=50'
HEET NO.

Exhibit B3-5

SCALE APPLICABLE FOR FULL SIZE ONLY

1. SEE DRAWING CV-LOO1-A11 FOR NOTES.

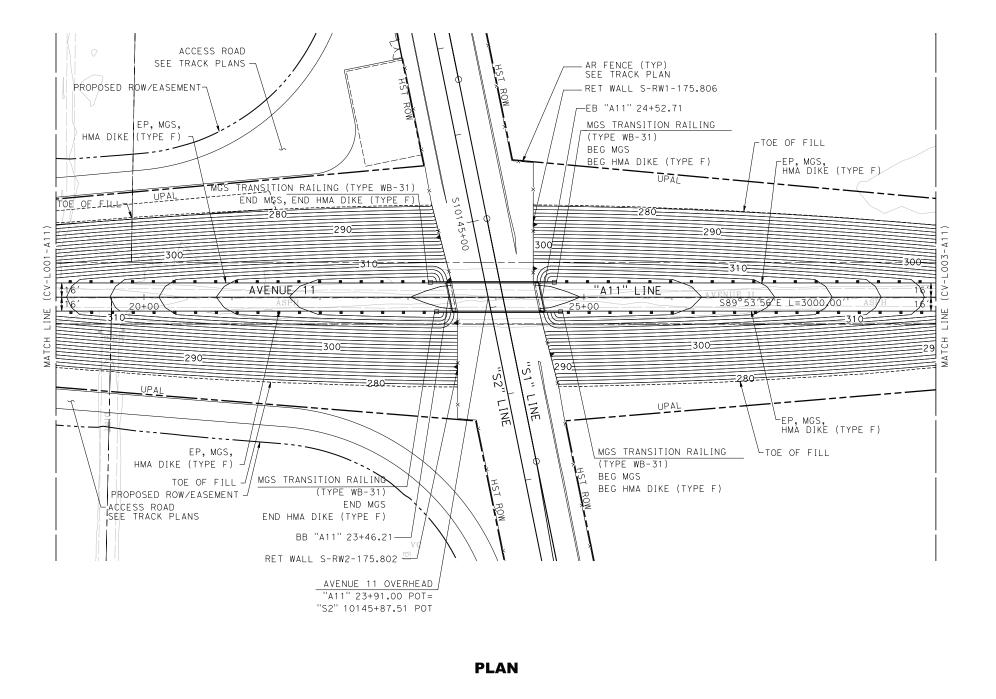


Exhibit B3-5.3

SCALE APPLICABLE FOR FULL SIZE ONLY

-							J. HANNA
ry.	0	05/08/15	JH	AA	мс	READY FOR CONSTRUCTION	DRAWN BY
	С	11/20/14				FINAL FACILITY PLAN	Y, SAIKALI CHECKED BY
022C	В	07/23/14				INTERMEDIATE FACILITY PLAN	A. ADHIKARY IN CHARGE
	Α	06/23/14				DESIGN BASELINE REPORT	M. COOPER
pood	REV	DATE	ВҮ	СНК	APP	DESCRIPTION	05/08/2015








CALIFORNIA HIGH-SPEED TRAIN PROJECT CONSTRUCTION PACKAGE 1

AVENUE 11 GRADE SEPARATION LAYOUT SHEET 2 OF 3

CONTRACT NO. HSR13-06
DRAWING NO. CV-L002-A11
1"=50'
SHEET NO. 5

1. SEE DRAWING CV-LOO1-A11 FOR NOTES.

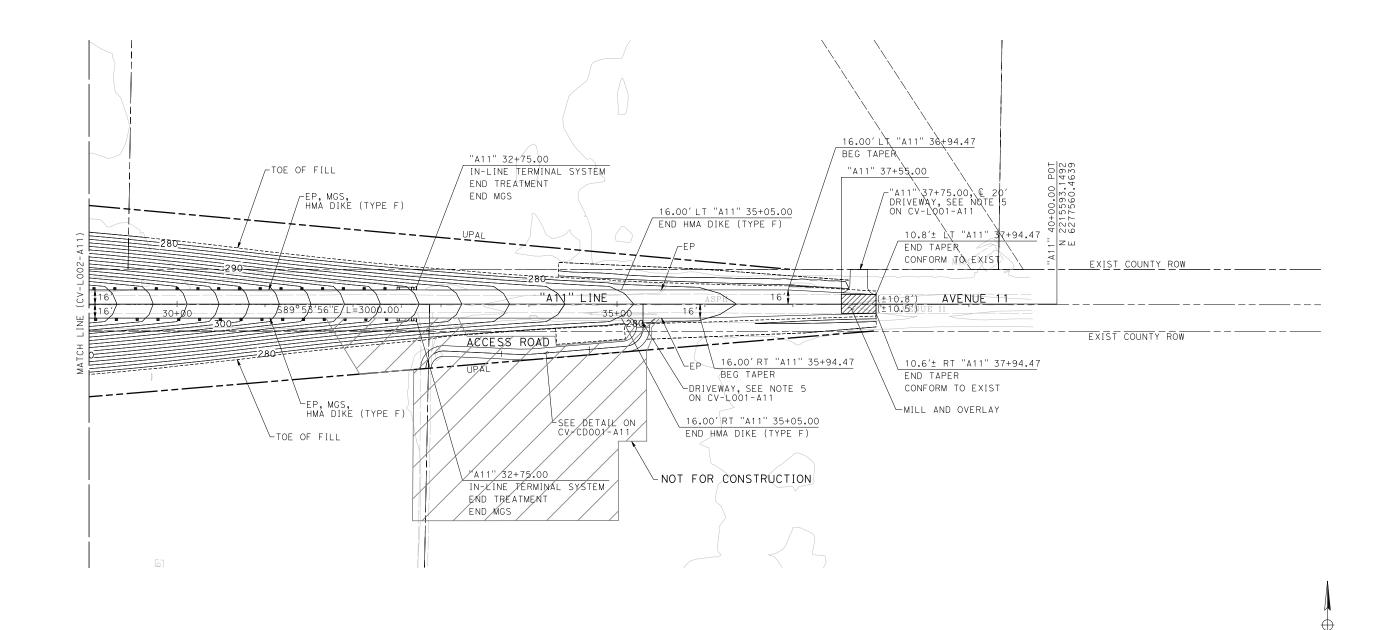

PLAN

							J. HANNA
	0	05/08/15	JH	AA	MC	READY FOR CONSTRUCTION	DRAWN BY
	С	11/20/14				FINAL FACILITY PLAN	Y. SAIKALI CHECKED BY
	В	07/23/14				INTERMEDIATE FACILITY PLAN	A. ADHIKARY
	Α	03/23/14				DESIGN BASELINE REPORT	M. COOPER
١	REV	DATE	BY	СНК	APP	DESCRIPTION	05/08/2015

REV DATE BY CHK APP



Tutor Perini ZACHRY' **PARSONS** A joint venture





CALIFORNIA HIGH-SPEED TRAIN PROJECT CONSTRUCTION PACKAGE 1


AVENUE 11 GRADE SEPARATION LAYOUT SHEET 3 OF 3

knibit B3-5.4
CONTRACT NO. HSR13-06
CV-LOO3-A11
1"=50'
6 6

SCALE APPLICABLE FOR FULL SIZE ONLY

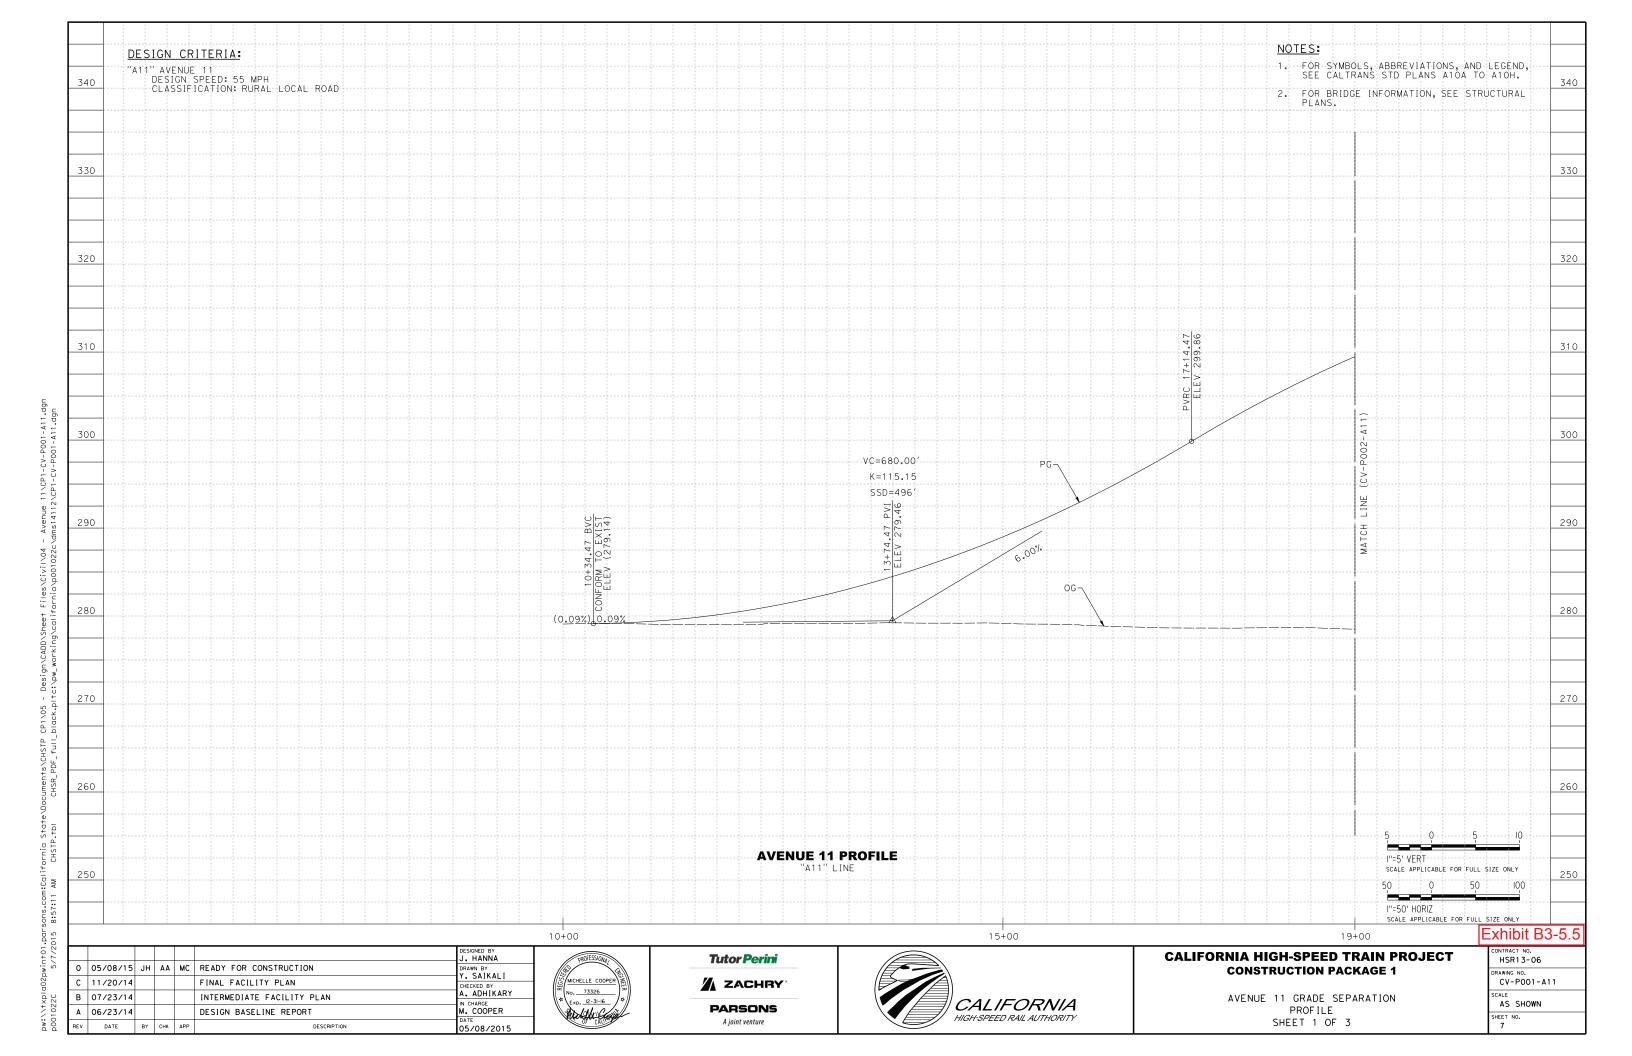

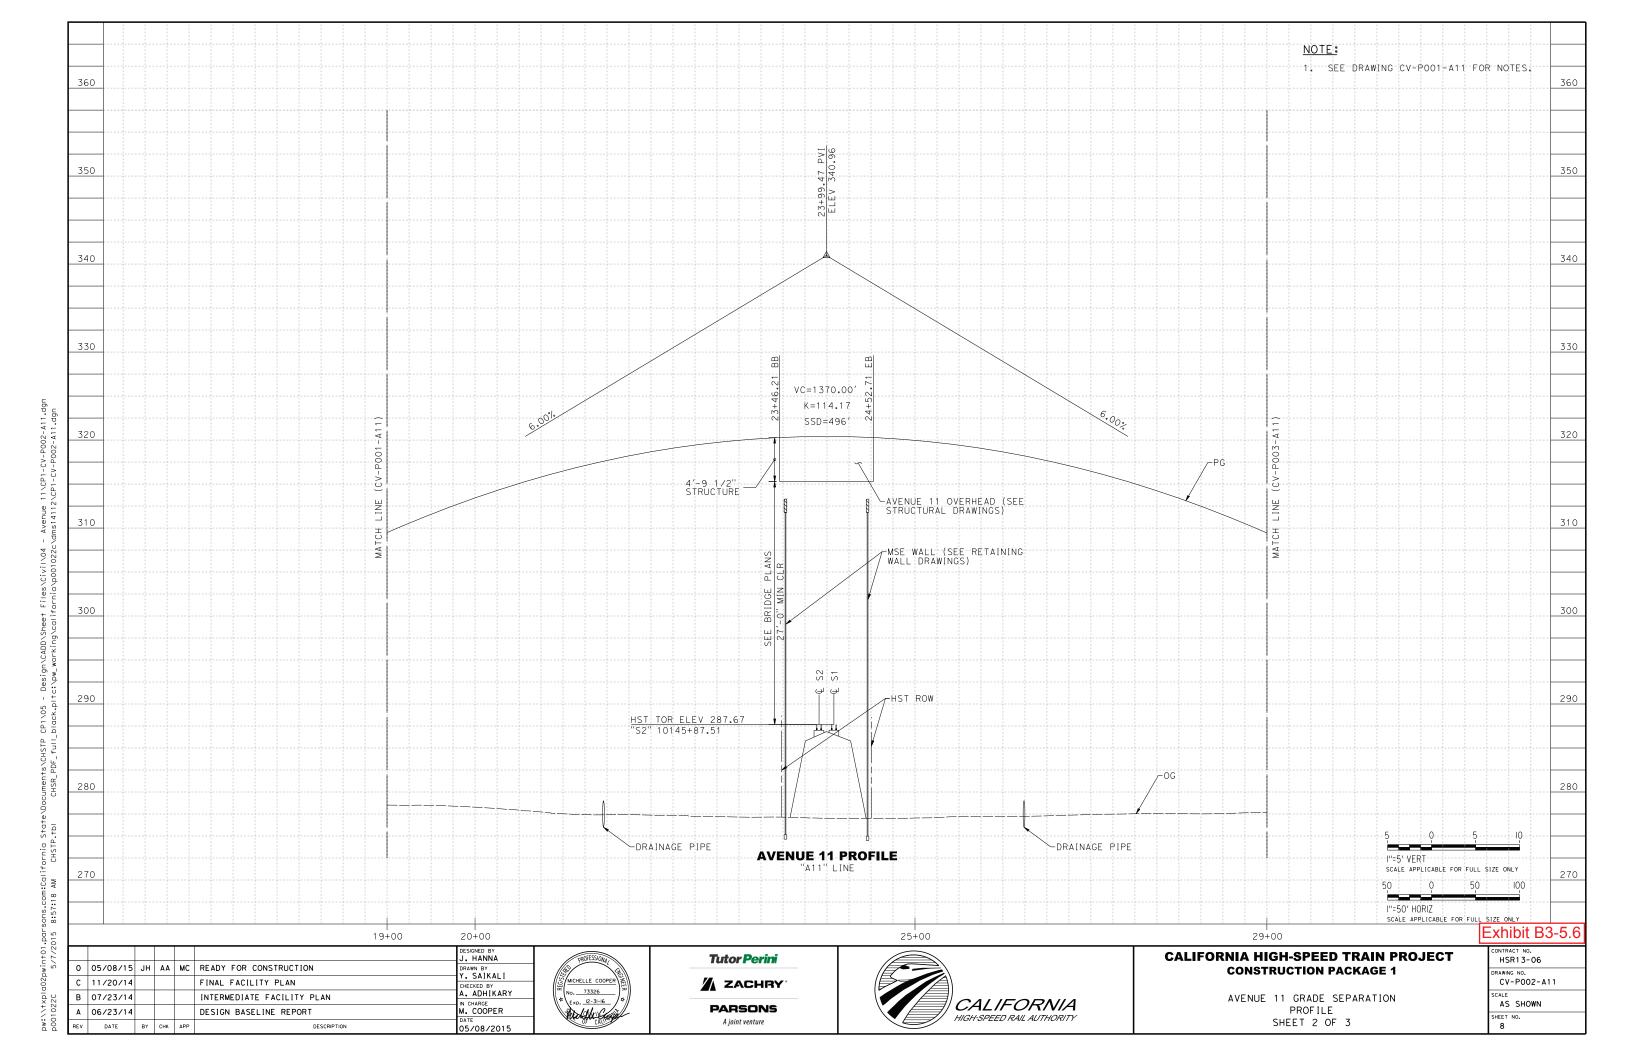

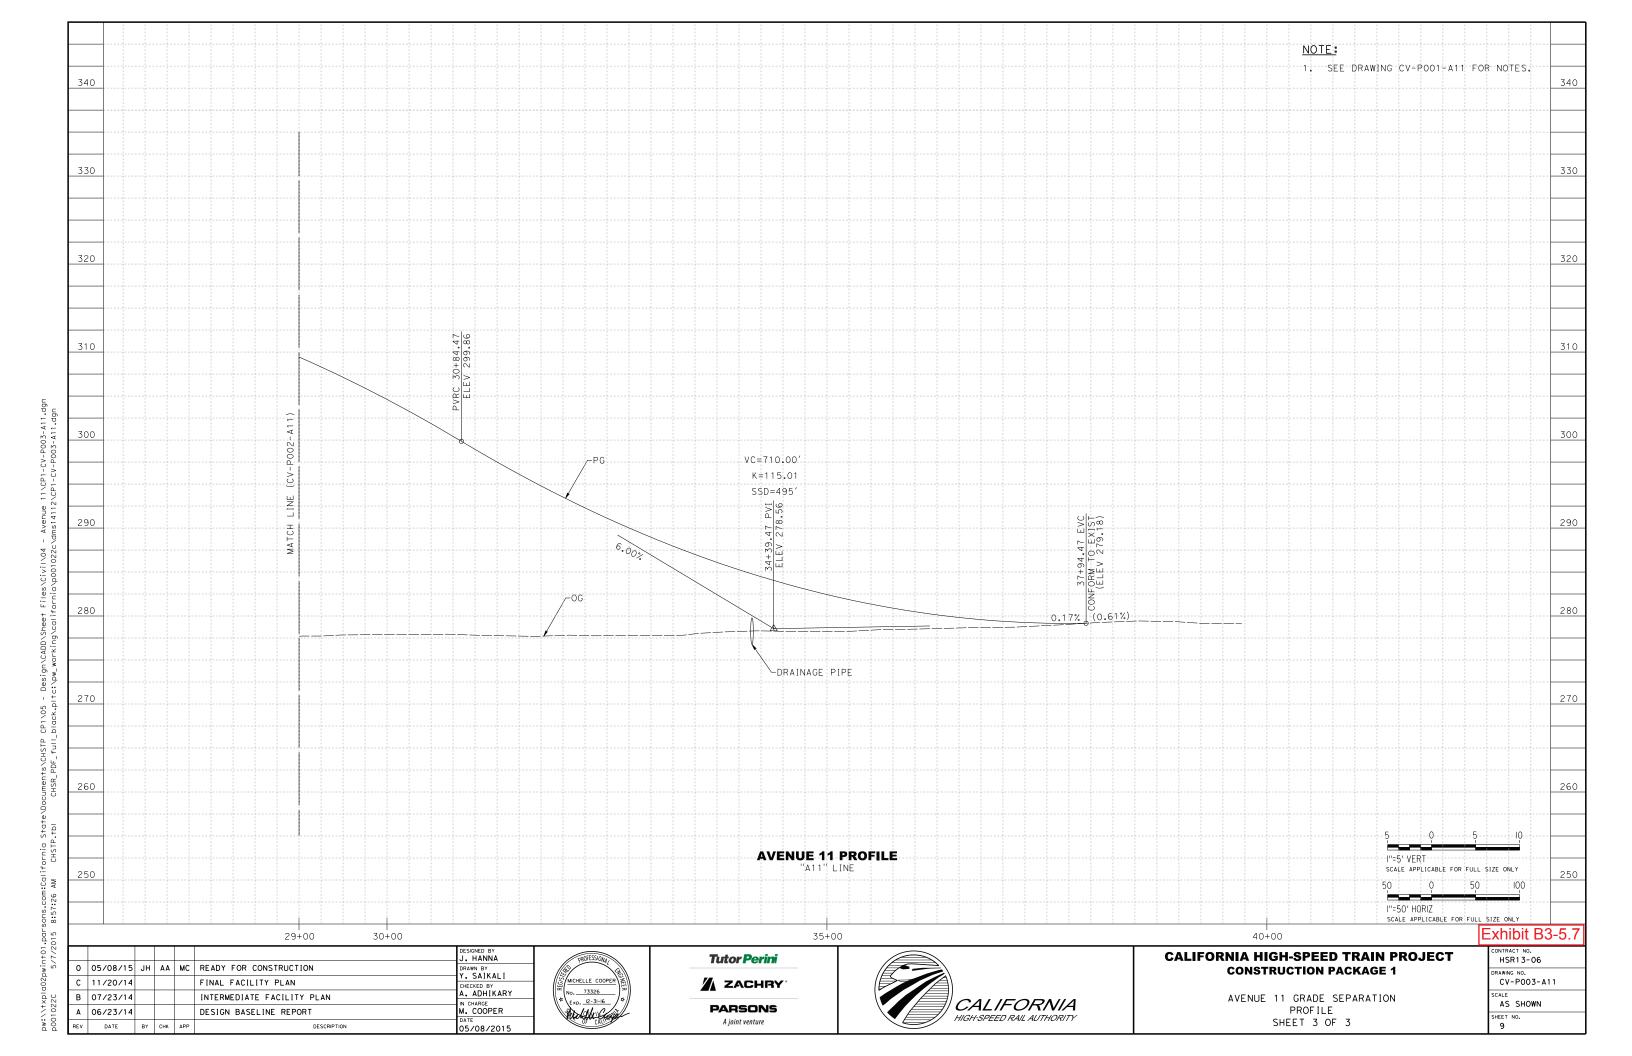


Project Drawings

Exhibit B3 – Roadway Drawings


Exhibit B3-6 - Avenue 12 HST


PAVEMENT SECTIONS

PAVEMENT SECTION APPLICABLE WHEN THE UPPER 4' OF NEW EMBANKMENT MATERIALS (MEASURED FROM THE GRADING PLANE) POSSESS A MINIMUM R-VALUE OF 50 AND A PLASICITY INDEX OF LESS THAN 12%. WHERE SUBGRADE DOES NOT MEET THESE REQUIREMENTS SEE GEOTECHNICAL ENGINEERING DESIGN REPORT AVENUE 12 OVERHEAD (NEW) FOR RECOMMENDATIONS.

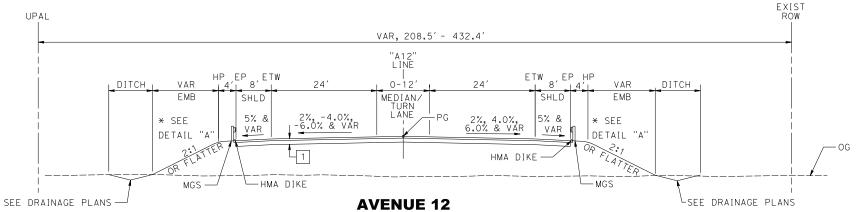


STA. 17+27.00 TO STA. 27+85.39 STA. 29+52.39 TO STA. 48+60.89 STA. 50+06.30 TO STA. 57+00.00

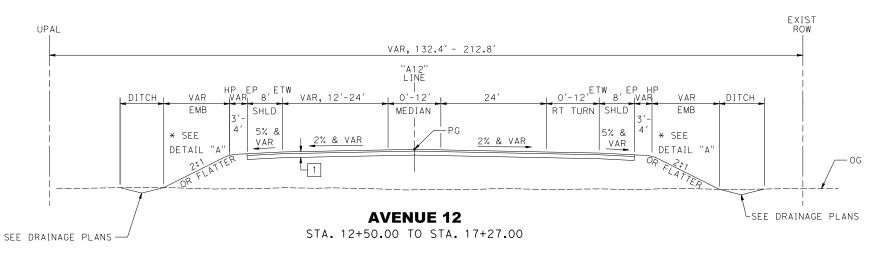

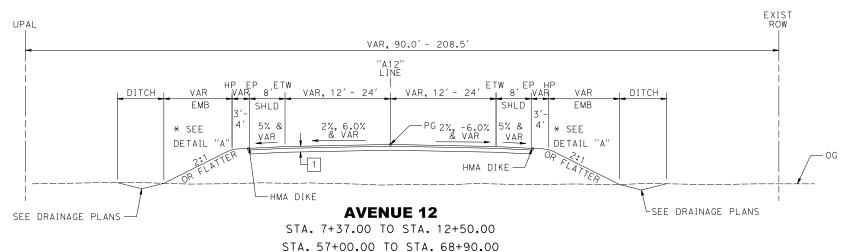

NOTES:

- 1. SEE DRAWING ST-K1100-A12 FOR TYPICAL SECTION STA. 27+85.39 TO STA. 29+52.39
- 2. SEE DRAWING ST-K1101-A12 FOR TYPICAL SECTION STA. 48+60.89 TO STA. 50+06.30
- 3. FOR EXISTING PAVEMENT MILLING AND OVERLAY LOCATIONS, SEE LAYOUT PLANS
- 4. FOR SHOULDER SLOPE TRANSITION AT BRIDGE APPROACHES, SEE CV-CD001-A12
- 5. SEE LAYOUT PLANS FOR MGS AND DIKE
- EARTHWORK SHALL BE CONSTRUCTED IN ACCORDANCE WITH THE MADERA COUNTY CONSTRUCTION SPECIFICATIONS, COUNTY OF MADERA SPECIAL PROVISIONS AND THE CONSTRUCTION RECOMMENDATIONS PRESENTED IN THE AVENUE 12 GEOTECHNICAL ENGINEERING DESIGN REPORT

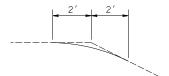

DETAIL "A" SLOPE ROUNDING

Exhibit B3-6.







CALIFORNIA HIGH-SPEED TRAIN PROJECT CONSTRUCTION PACKAGE 1

AVENUE 12 GRADE SEPARATION TYPICAL SECTIONS SHEET 1 OF 2 ONTRACT NO.
HSR13-06
RAWING NO.
CV-XOO1-A12
CALE
NO SCALE
HEET NO.
3

FOR HOT MIX ASPHALT DIKE DETAILS, SEE CALTRANS STD PLAN A87B & A77N4.

FOR MIDWEST GUARDRAIL SYSTEM (MGS) DETAILS, SEE CALTRANS STD PLAN A77P2 & A77N4.

4. FOR MGS TRANSITION RAILING(TYPE WB-31) AND CONNECTION DETAILS TO BRIDGE RAILING, SEE CALTRANS STD PLAN A77U1, A77U2. AND A77U4.

5. FOR DRIVEWAY DETAILS, SEE COUNTY OF MADERA STD PLANS ST-25 AND ST-27. 2.5" HMA OVER 6" AB.

- 6. FOR RETAINING WALL DETAILS, SEE SHEETS CV-RW001-A12 TO CV-RW005
- FOR DRAINAGE DETAILS, SEE SHEETS CV-D001-A12 TO CV-DD002-A12.
- FOR PAVEMENT DELINEATION & SIGNING DETAILS, SEE SHEETS CV-PD001-A12 TO CV-PD005-A12.
- 9. FOR STRUCTURES DETAILS, SEE SHEETS ST-K1100-12H TO ST-K1101-12B.
- 10. HST/MADERA COUNTY ROW TBD BASED ON FINAL AGREEMENT BETWEEN THE AUTHORITY AND MADERA COUNTY.

DESIGN CRITERIA

"A12" AVENUE 12 DESIGN SPEED: 55 MPH CLASSIFICATION: RURAL ARTERIAL

"12A" ACCESS ROAD A
DESIGN SPEED: 25 MPH
CLASSIFICATION: RURAL LOCAL ROAD

"12B" ACCESS ROAD B DESIGN SPEED: 25 MPH CLASSIFICATION: RURAL LOCAL ROAD

"12C" ACCESS ROAD C
DESIGN SPEED: 15 MPH
CLASSIFICATION: RURAL LOCAL ROAD

2000-001 07°12′51"L 126.08′ 251.82 89°28′04"L 44.58′ 70.27 45.00' 06°44′03"R 23.53′ 400.00' 47.01 () 1975.00′ 06°36′41"L 114.07′ 227.89′ (1) 500.00' 03°32'36"L 15.47' 30.92'


IN-LINE TERMINAL

SYSTEM END TREATMENT

CURVE DATA

38.00' RT "A12" 17+39.04 EC SEE NOTE 3 38.00' RT "A12" 19+20.00 BEG MGS HMA DIKE (TYPE F) 37.24' LT "A12" 16+85.00 38.00'LT "A12" 19+20.00 BEG HMA DIKE (TYPE F)

BEG MGS IN-LINE TERMINAL HMA DIKE (TYPE F) SYSTEM END TREATMENT

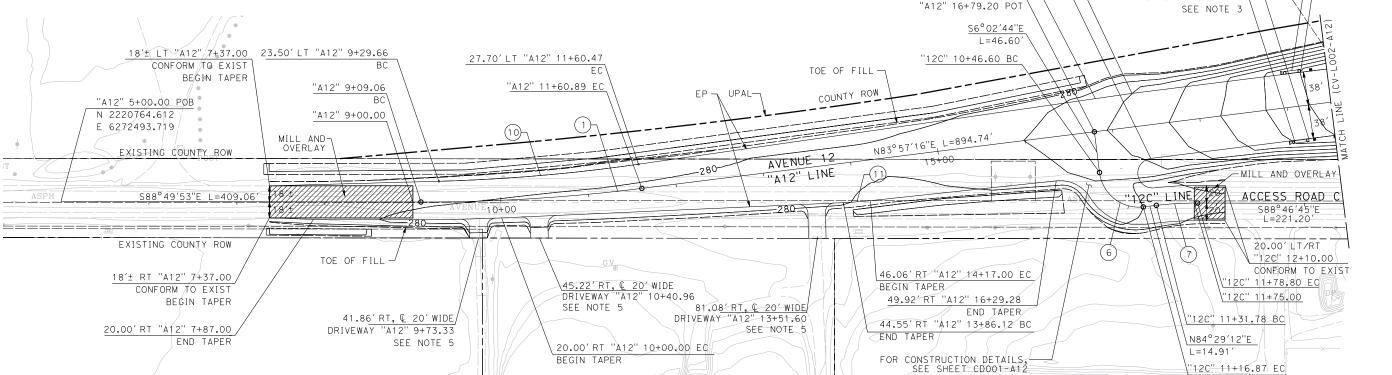

PLAN

SIGNED BY O | 05/08/15 | JH | AA | MC | READY FOR CONSTRUCTION MORTON C 05/01/15 BNSF CONCEPT PLANS ECKED BY ADHIKARY B 10/27/14 FINAL FACILITY PLAN M. COOPER A 04/29/14 INTERMEDIATE FACILITY PLAN DATE BY CHK APP



Tutor Perini ZACHRY **PARSONS** A joint venture

TANK



38.00' LT "A12" 17+27.00

"12C" 10+00.00 POB =

END TAPER


CALIFORNIA HIGH-SPEED TRAIN PROJECT

SCALE APPLICABLE FOR FULL SIZE ONLY

AVENUE 12 GRADE SEPARATION LAYOUT SHEET 1 OF 5

CONSTRUCTION PACKAGE 1

E	Exhibit B3-6.2							
	CONTRACT NO.							
	HSR13-06							
	DRAWING NO.							
	CV-L001-A12							
	SCALE							
	1" = 50'							
	SHEET NO.							
	5							

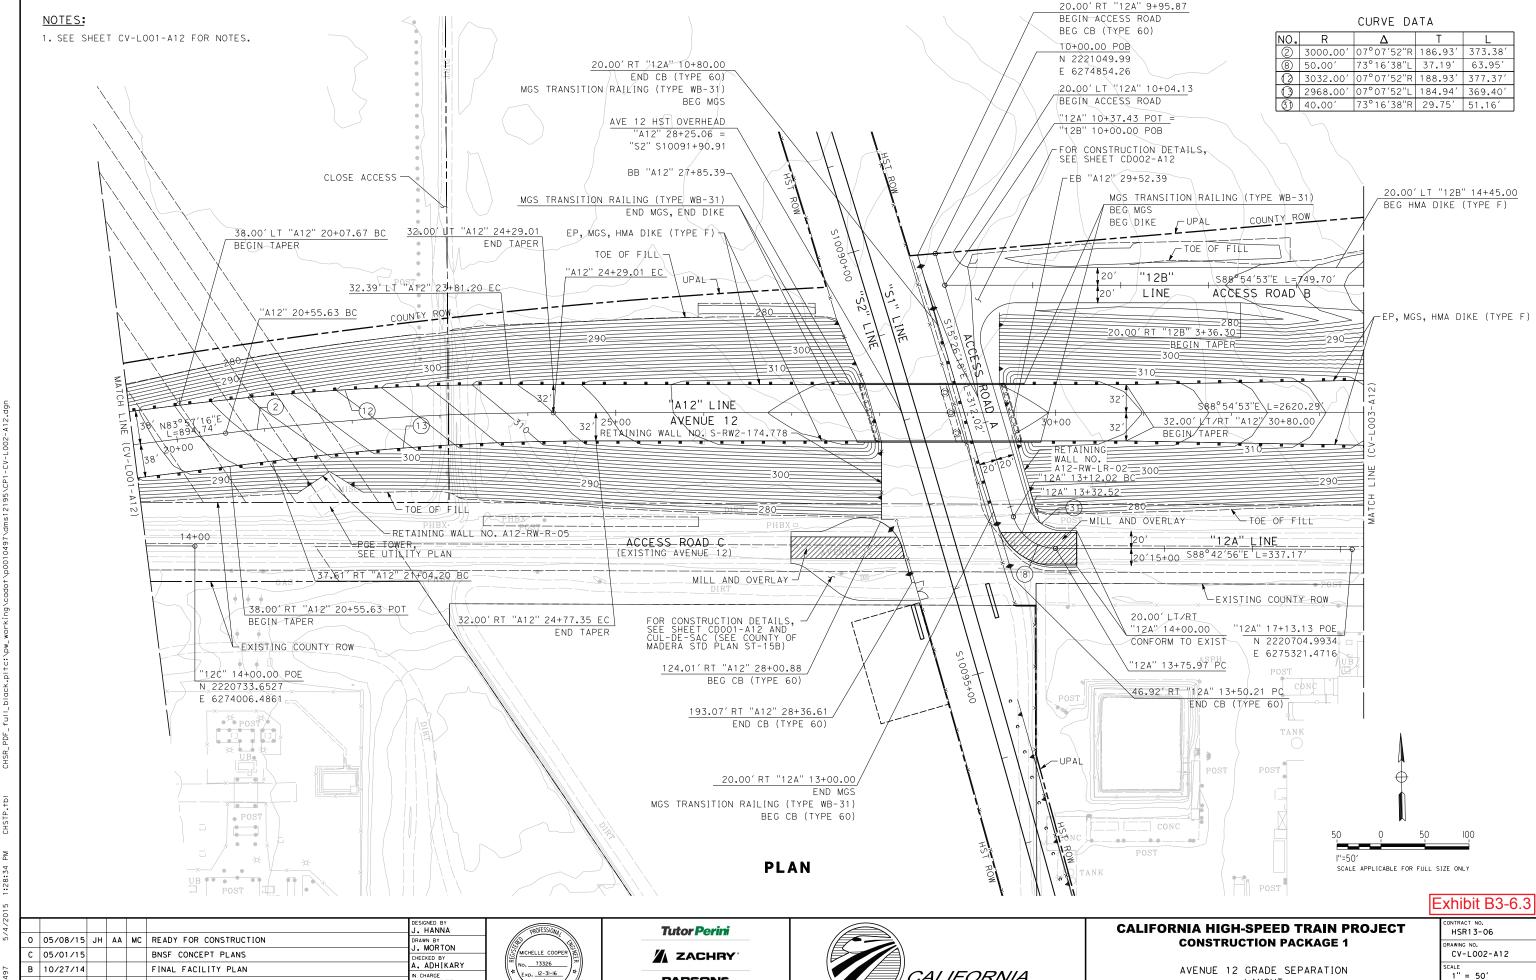

CALIFORNIA

LAYOUT

SHEET 2 OF 5

Exp. 12-31-16

Martin Gar

PARSONS


A joint venture

M. COOPER

A 04/29/14

DATE BY CHK APP

INTERMEDIATE FACILITY PLAN

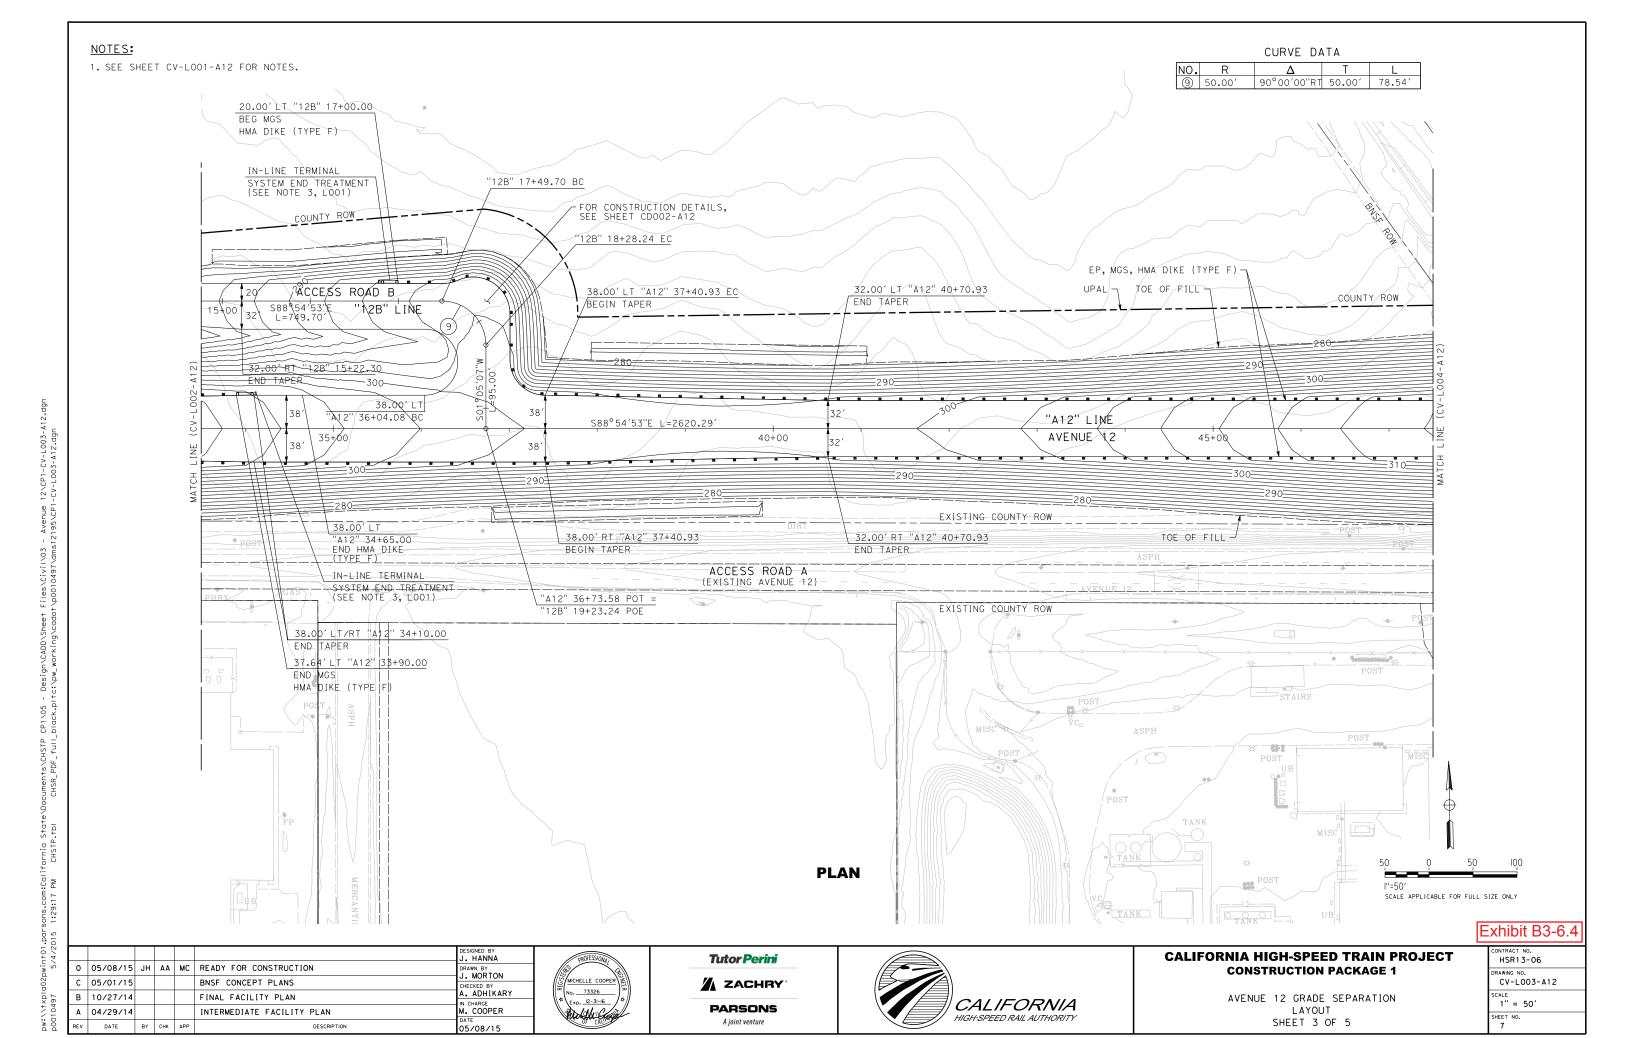

NOTES: DESIGN CRITERIA 1. FOR SYMBOLS, ABBREVIATIONS, AND LEGEND SEE CALTRANS STD PLANS A10A TO A10H. "A12" AVENUE 12
DESIGN SPEED: 55 MPH
CLASSIFICATION: RURAL ARTERIAL 2. FOR BRIDGE INFORMATION SEE STRUCTURAL PLANS. "12A" ACCESS ROAD A
DESIGN SPEED: 25 MPH
CLASSIFICATION: RURAL LOCAL ROAD "12B" ACCESS ROAD B
DESIGN SPEED: 25 MPH
CLASSIFICATION: RURAL LOCAL ROAD "12C" ACCESS ROAD C
DESIGN SPEED: 15 MPH
CLASSIFICATION: RURAL LOCAL ROAD 340 340 330 330 320 320 18+65,00 EVC ELEV 289,57 300 300 PV/ PV/ 1.37 8.85 = 20 MCESS ROAD C PV/ ACCESS ROAD C ELEY 283.64 VC=460.00 VC=100.00' VC=100.00' K=200.92 K=168.68 SSD=2218' S\$D=688' 10+50.00 PVI ELEV 280.37 16+35.00 PVI ELEV 280.37 10+00.00 BVC ELEV 280.13 11+00.00 EVC ELEV 280.37 8+37,00 EVC ELEV 279,31 7+37.00 BVC ELEV 279.11 7+87.00 PVI ELEV 279.07 290 280 0.50% 270 .!"=5' VERT. SCALE APPLICABLE FOR FULL SIZE ONLY 100 **AVENUE 12 PROFILE** I''=50' HORIZ "A12" LINE SCALE APPLICABLE FOR FULL SIZE ONLY 10+00 15+00 20+00 Exhibit B3-6. SIGNED BY **CALIFORNIA HIGH-SPEED TRAIN PROJECT** HSR13-06 **Tutor Perini** 0 05/08/15 JH AA MC READY FOR CONSTRUCTION **CONSTRUCTION PACKAGE 1** MORTON RAWING NO. MICHELLE COOPER BNSF CONCEPT PLANS CV-P001-A12 C 05/01/15 ZACHRY ECKED BY No. __73326 # Exp. __12-31-16 B 10/27/14 FINAL FACILITY PLAN AVENUE 12 GRADE SEPARATION CALIFORNIA AS SHOWN M. COOPER **PARSONS PROFILES** A 04/29/14 INTERMEDIATE FACILITY PLAN

A joint venture

SHEET 1 OF 5

0 ₹

DATE BY CHK APP

DESCRIPTION

