

BEFORE THE PUBLIC UTILITIES COMMISSION OF THE STATE OF CALIFORNIA

A1708019

Application of the California High-Speed Rail Authority to construct proposed high-speed tracks and underpass grade separations at SR99 (MP 195.74) and SR99 Ramp (MP 195.83) within the City of Fresno, California.

Application No.	
, .pp	

APPLICATION

The California High-Speed Rail Authority (CHSRA or Applicant) hereby respectfully requests authority from the California Public Utilities Commission (CPUC or Commission) to construct proposed tracks and highway-rail underpass grade separations in the City of Fresno at State Route 99 (SR99), and the southbound entrance ramp to State Route 99 from S. Cedar Avenue (SR99 Ramp), which are part of the proposed California High-Speed Train System (CHSTS).

In support of this application the Applicant asserts that:

- 1. The Applicant's exact legal name is California High-Speed Rail Authority and CHSRA is a public agency formed pursuant to the California High-Speed Rail Act (California Public Utilities Code § 185000 *et seq.*).
- 2. The Applicant's principal place of business is California High-Speed Rail Authority, 770 L Street, Suite 620; Sacramento, CA 95814. The main telephone number is (916) 324-1541.
- 3. All correspondence, communication, notices, orders and other papers relative to this application should be addressed to: Bruce W. Armistead, Director of

Operations and Maintenance, at the above address and at the following e-mail address: Bruce.Armistead@hsr.ca.gov. Mr. Armistead is an employee of CHSRA and the Applicant's authorized agent.

4. The proposed mainline tracks and underpass grade separations at SR99, and SR99 Ramp are a part of the California High-Speed Train Project Construction Package 1 (CP1 Project), which is the first construction package of the CHSTS. CHSRA is working cooperatively with the stakeholders along the corridor, which include government agencies and railroads.

The CP1 Project limits begin in Madera County in the north and extend south through the City of Fresno, into unincorporated Fresno County. The CP1 Project length is approximately thirty miles and consists of two CHSTS mainline tracks, generally aligned in a north-south direction.

Grade separations allow for the safe and simultaneous movement of highway and rail modes of travel. With that consideration, the proposed highway-rail and rail-rail crossings of the CP1 Project include nineteen (19) new grade separations, modification of thirteen (13) existing at-grade crossings to grade separations, and modification of six (6) existing grade separations. Eight (8) existing public at-grade crossings and one (1) grade separated crossing are proposed to be closed. No new at-grade crossings are proposed for the CP1 Project.

For the protection of the general public and CHSTS passengers, the CHSTS will be a closed corridor. Unauthorized access to CHSRA right-of-way will be protected with the use of a continuous Access Restricted (AR) fence or barrier. The typical AR fence consists of an eight foot (8 ft) welded wire mesh, which is more resistant to climbing and forced entry than chain link fence. When required by CHSRA criteria, expanded metal mesh fence or barrier walls will be used. In addition to the AR fence or barrier walls, intrusion monitoring and detection are proposed. CHSRA will employ security services to enforce right-of-way access restrictions.

The overhead contact system, which will supply energy to the rail vehicles, is consistent with the requirements of General Orders 26-D, 95, 128 and 176.

- 5. This application and relief sought herein is filed pursuant to Sections 1201 through 1205, inclusive, of the Public Utilities Code and in accordance with Rules 3.7 and 3.9 of the Commission's Rules of Practice and Procedure.
- 6. The CHSRA, in cooperation with the City of Fresno and the California Department of Transportation District 6 (Caltrans), proposes to construct two CHSTS mainline tracks and underpass grade separation structures at SR99, and SR99 Ramp in the City of Fresno. The existing roadways will remain at-grade, and the proposed mainline tracks will be constructed on elevated structures.

For each of the proposed crossings, the CHSTS mile post, proposed CPUC crossing number and DOT crossing number are listed in the following table. These crossings are along the CHSTS Sierra Subdivision.

Crossing Name	Mile Post	Proposed CPUC #	Proposed DOT #
State Route 99	195.74	135S-195.74-B	968 530R
State Route 99 Ramp	195.83	135S-195.83-B	968 531X

- 7. The legal descriptions for the locations of the proposed CHSTS grade separations at SR99, and SR99 Ramp (Rule 3.7(a)) are provided in Exhibit A, attached hereto and made a part hereof.
- 8. The crossing identification numbers of the nearest existing public crossings on each side of the proposed crossings (Rule 3.7(b)) are as follows: the nearest existing crossing to the north of the proposed crossings at SR99 and SR99 Ramp is the BNSF spur crossing at S. Cedar Avenue (CPUC No. 002-994.6-C and DOT No. 028466A) and to the south is the BNSF crossing at S. Calway OH SR99 (CPUC No. 002-993.8-A and DOT No. 028463E). These crossings are located in the City of Fresno.
- 9. CP1 Project design drawings showing the general vicinity (Rule 3.7 (e)), proposed horizontal and vertical alignment for the two CHSTS tracks (Rule 3.7 (f) and 3.9 (c)), and structure design drawings (Rule 3.7 (d)) are provided in Exhibit B, attached hereto and made a part hereof. Since the roadways over which the rail lines will be constructed are remaining in place with minimal or no modification, roadway plan and profile drawings for SR99, and SR99 Ramp (Rule

3.7 (d) and Rule 3.7 (f)) are not included. The width of existing roadways and vertical clearance dimensions are provided on the structural drawings in Exhibit B.

The following tables summarize the minimum temporary and permanent clearances illustrated on the design drawings in Exhibit B. The permanent clearances meet or exceed those required by General Order 26-D.

Temporary	Roadwa	ay Clearances	Track Clearances		
Clearances	Minimum	Minimum	Minimum	Minimum	
	Vertical	Horizontal	Vertical	Horizontal	
State Route 99	15' 4"	40' 0" (total width)	N/A	N/A	
State Route 99 Ramp	15' 4"	20' 0" (total width)	N/A	N/A	

Permanent	Roadwa	ay Clearances	Track Clearances		
Clearances	Minimum	Minimum	Minimum	Minimum	
	Vertical	Horizontal	Vertical	Horizontal	
State Route 99	33' 9"	56' (NB total width)	N/A	>10' *	
State Route 99 Ramp	19' 8"	24' (total width)	N/A	>10' *	
* Distance is from center	erline of track	to face of OCS po	le.		

In support of the proposed underpass grade separations at SR99, and SR99
 Ramp, a letter of concurrence from Caltrans is provided in Exhibit C, attached hereto and made a part hereof.

The agreement between CHSRA and Caltrans (Rule 3.9 (a)), entitled Master Agreement between the California High-Speed Rail Authority and the California Department of Transportation for Construction Project Work Located within the CROW [Caltrans Right of Way] (Post PA&ED), was provided to the Commission as Exhibit C2 to Application A.16-05-016, and is made a part hereof by reference. A Notice of Availability and Certificate of Service for the CHSRA and Caltrans agreement are filed with this application.

11. The CHSRA, as the lead agency under the provisions of the California Environmental Quality Act (CEQA), prepared the *Final Environmental Impact*

Report/ Environmental Impact Statement (Final EIR/EIS) for the Fresno to Bakersfield Section of the California High-Speed Train Project. The Federal Railroad Administration (FRA) was the lead agency under the National Environmental Policy Act (NEPA). The Notice of Determination (NOD) for the Final EIR/EIS was certified on May 7, 2014 (State Clearinghouse No. 2009091126), and the Record of Decision (ROD) was dated June 27, 2014. The Final EIR/EIS for the Fresno to Bakersfield Section of the California High-Speed Train Project was provided to the Commission (Rule 2.4) on archival and standard CD-ROM/DVD as Exhibit D to Application A. 17-05-014. The Final EIR/EIS is made a part hereof by reference. A Notice of Availability for the Final EIR/EIS and Certificate of Service are filed with this application.

- 12. Attached hereto as Exhibit D is the Scoping Memo for this application.
- 13. Attached hereto as Exhibit E is the Verification for this application.

WHEREFORE, the Applicant respectfully requests:

- That the Public Utilities Commission of the State of California issue an Order authorizing construction of the underpass grade separations of SR99, and SR99 Ramp and CHSTS mainline tracks pursuant to the provisions of Sections 1201-1205, inclusive, of California Public Utilities Code.
- 2. That the Order provides seventy-two (72) months from the date of such an Order within which to complete the work requested. This extended period of time is requested due to the complexity, size and unique nature of the CP1 Project.

The CP1 Project scope includes the design and construction of the structures and track roadbed, encompassing nearly 50 crossings. To complete construction at the subject crossings and all of the crossings along the length of the CP1 Project, CHSRA anticipates issuing a separate contract within several years for construction of the proposed tracks and overhead contact system. The construction of the CP1 Project and the future track work contract will not be complete within the standard 36-month authorization period but is likely to be completed within 72 months. In addition, since the proposed crossings are grade separations, the clearances and crossing configurations are well defined and not

subject to the variability common for at-grade crossings. Given the number of new CHSTS crossing requests that will be submitted to the CPUC in the coming months and years, authorizing the extended period for this crossing will relieve both the CP1 Project and CPUC staff of preparing and processing numerous crossing extensions that will result with a 36-month Order.

Signed_

Pruce W. Armistead

Director of Operations and Maintenance California High-Speed Rail Authority

770 L Street, Suite 620 Sacramento, CA 95814

Tel: (916) 324-1541

E-Mail: Bruce.Armistead@hsr.ca.gov

List of Exhibits

Exhibit A	Crossing Legal Descriptions A1 – State Route 99 A2 – State Route 99 Ramp	
Exhibit B	Project Drawings B1 – Vicinity Map B2 – Structure Drawings General Plans & Elevations Cross Sections B3 – Guideway Drawings Track Chart Guideway Plan and Profile	Page 1 Page 2 Page 2 Page 5 Page 8 Page 8
Exhibit C	Local Project Support Caltrans Concurrence	
Exhibit D Exhibit E	Scoping Memo Verification	

Supporting Documents

Notice of Availability

Exhibit C2 to Application A. 16-05-016

Master Agreement between the California High-Speed Rail Authority and the California Department of Transportation for Construction Project Work within the CROW (Post PA&ED)

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Exhibit D to Application A. 17-05-014

Final Environmental Impact Report/ Environmental Impact Statement for the Fresno to Bakersfield Section of the California High-Speed Train Project

Certificate of Service

Exhibit A

Crossing Legal Descriptions

Exhibit A1 – State Route 99

NUMBER: FB-10-9098

EXHIBIT "A" LEGAL DESCRIPTION

PARCEL FB-10-9098 (AERIAL EASEMENT at State Route 99)

An aerial easement over and across that portion of land situated in the City of Fresno, County of Fresno, State of California, being a portion of the Northwest Quarter of Section 25 all in Township 14 South, Range 20 East, Mount Diablo Base and Meridian, said portion described as follows;

COMMENCING at the Northwest Quarter Corner of said Section 25; thence along the West Line of said Section 25, South 00°34'59" West, 917.40 feet to the beginning of a non-tangent curve concave southwesterly, to which point a radial line bears North 71°07'08" East; thence leaving said West Line, southeasterly along said curve, having a radius of 21318.25 feet, through a central angle of 00°45'35", and arc length of 282.63 feet to the northerly outside edge of bridge deck and the **POINT OF BEGINNING**,

Thence northeasterly leaving said curve, along the outside edge of said deck, North 72°28'06" East, 4.65 feet to the northeasterly corner of said deck; thence southeasterly along the outside edge of said deck the following seventeen (17) courses and distances: (1) South 17°31'54" East, 20.00 feet; (2) thence South 06°13'18" East, 5.10 feet; (3) thence South 17°31'54" East, 56.83 feet; (4) thence South 28°50'30" East, 5.10 feet; (5) thence South 17°31'54" East, 0.67 feet to the beginning of a non-tangent curve concave southwesterly, to which point a radial line bears North 09°44'53" East; (6) thence southeasterly along said curve, having a radius of 6.00 feet, through a central angle of 125°26'27", and arc length of 13.14 feet; (7) thence leaving said curve, South 17°31'54" East, 14.67 feet; (8) thence South 06°13'18" East, 5.10 feet; (9) thence South 17°31'54" East, 122.00 feet; (10) thence South 28°50'30" East, 5.10 feet; (11) thence North 81°12'52" East, 3.29 feet; (12) thence South 17°31'54" East, 39.00 feet; (13) thence South 63°43'20" West, 3.29 feet; (14) thence South 06°13'18" East, 5.10 feet; (15) thence South 17°31'54" East, 122.00 feet; (16) thence South 28°50'30" East, 5.10 feet; (17) thence South 17°31'54" East, 20.00 feet the southeasterly corner of said deck; thence southwesterly along the outside edge of said deck, South 72°28'06" West, 51.17 feet to the southwesterly corner of said deck; thence northwesterly along the outside edge of said deck the following seventeen (17) courses and distances: (1) thence North 17°31'54" West, 20.00 feet; (2) thence North 06°13'18" West, 5.10 feet; (3) thence North 17°31'54" West, 56.83 feet; (4) thence North 28°50'30" West, 5.10 feet; (5) North 17°31'54" West, 0.67 feet to the beginning of a non-tangent curve concave northeasterly, to which point a radial line bears South 09°44'53" West; (6) thence northwesterly along said curve, having a radius of 6.00 feet, through a central angle of 125°26'27", and arc length of 13.14 feet; (7) thence North 17°31'54" West, 14.67 feet; (8) thence North 06°13'18" West, 5.10 feet; (9) thence North 17°31'54" West, 122.00 feet; (10) thence North 28°50'30" West, 5.10 feet; (11) thence South 81°12'52" West, 3.29 feet; (12) thence North 17°31'54" West, 39.00 feet; (13) thence North 63°43'20" East, 3.29 feet; (14) thence North 06°13'18" West, 5.10 feet; (15) thence North 17°31'54" West, 122.00 feet; (16) thence North 28°50'30" West, 5.10 feet; (17) thence North 17°31'54" West, 20.00 feet to the northwesterly corner of said deck; thence northeasterly along the outside edge of said deck, North 72°28'06" East, 46.52 feet to the **POINT OF BEGINNING.**

The bearings and distances used in the above description are based on the California Coordinate System 1983, Zone 4, as shown on Record of Survey, Book 58, pages 71 to 72, Epoch 2007.00. Multiply distances shown above by 1.000066514 to obtain ground level distances.

END OF DESCRIPTION

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This real property description has been prepared by me, or under my direction, in conformance with the Professional Land Surveyors' Act.

Gregory L. Rice

Licensed Land Surveyor

California No. 8201

No. 8201

Date

Exhibit A

Crossing Legal Descriptions

Exhibit A2 – State Route 99 Ramp

NUMBER: FB-10-9099

EXHIBIT "A" LEGAL DESCRIPTION

PARCEL FB-10-9099 (AERIAL EASEMENT at State Route 99/Cedar Avenue SB On-Ramp)

An aerial easement over and across that portion of land situated in the City of Fresno, County of Fresno, State of California, being a portion of the Southwest Quarter of the Northwest Quarter of Section 25, Township 14 South, Range 20 East, Mount Diablo Base and Meridian, said portion described as follows;

COMMENCING at the most northeasterly corner of that certain parcel as described in Book 7833 at Page 786, recorded May 18, 1978, Official Records of said County, said point also being on the southwesterly line of U.S. Highway 99 as described in said Book 7833 at Page 786; thence along said southwesterly line, North 68°51'41" West, 22.46 feet to the southerly outside edge of bridge deck and the **POINT OF BEGINNING**

Thence southwesterly along the outside edge of said deck, South 73°59'59" West, 19.43 feet to the southwesterly corner of said deck, said point being the beginning of a non-tangent curve concave southwesterly, to which point a radial line bears North 73°59'59" East; thence northwesterly along said curve, and along the outside of edge of said deck, having a radius of 21275.25 feet, through a central angle of 00°29'04", and arc length of 179.89 feet to the northwesterly corner of said deck; thence leaving said curve, along the outside edge of said deck, North 73°30'55" East, 43.00 feet to the northeasterly corner of said deck, said point being the beginning of a non-tangent curve concave southwesterly, to which point a radial line bears North 73°30'55" East; thence southeasterly along said curve, and along the outside of edge of said deck, having a radius of 21318.25 feet, through a central angle of 00°29'04", and arc length of 180.25 feet to the southeasterly corner of said deck; thence leaving said curve, along the outside edge of said deck, South 73°59'59" West, 23.57 feet to the **POINT OF BEGINNING**.

The bearings and distances used in the above description are based on the California Coordinate System 1983, Zone 4, as shown on Record of Survey, Book 58, pages 71 to 72, Epoch 2007.00. Multiply distances shown above by 1.000066514 to obtain ground level distances.

END OF DESCRIPTION

No. 8201

Date

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Gregory L. Rice

Licensed Land Surveyor

California No. 8201

Exhibit B

Project Drawings

Exhibit B1 – Vicinity Map



90% DESIGN SUBMITTAL CALIFORNIA HIGH-SPEED TRAIN PROJECT CONSTRUCTION PACKAGE 1

DOWNTOWN FRESNO VIADUCT

GOLDEN STATE BLVD

DOWNTOWN FRESNO VIADUCT



COLDEN STATE BLVD

COARSEGOLD MADERA COUNTY FRESNO COUNTY BNSF FRESNO WINGSBURG TO PALMDALE HANFORD

PROJECT LOCATION MAP

FID: S-AS-195.1

HSR13-06

NO SCALE

ST-J0002-DFV

CALIFORNIA HIGH-SPEED TRAIN PROJECT CP-I	С	09/14/16				90% DESIGN SUBMITTAL	DESIGNED BY D. GETTER	Tutor Perini
AGREEMENT NO.: HSRI3-06 SUBMITTAL REVIEW IN ACCORDANCE WITH BOOK 2.	С	08/05/16	DG	DJ	DJ	ESOC-003 - COLUMN FLARES, BEARINGS & ABUTMENTS	DRAWN BY	rator r Crim
PART B - GENERAL PROVISIONS - SECTION 61.2	b	04/08/16	DG	DJ	DJ	ESOC-002 - BENT FOUNDATIONS & COLUMNS	J. GILMORE CHECKED BY	ZACHRY
APPROVED	a	11/13/15	SD	FN	SD	ESOC - 001 - FOUNDATIONS ONLY	D. JONES	
SIGNED	В	08/15/15				60% DESIGN SUBMITTAL	D. JONES	PARSONS
DATE	REV	DATE	BY	СНК	APP	DESCRIPTION	09/14/2016	A joint venture


Exhibit B

Project Drawings

Exhibit B2 – Structure Drawings

NOTE:

1. FOR NOTES, TOP OF RAIL PROFILE, AND LEGEND, SEE "GENERAL PLAN AND ELEVATION SHEET 1 OF 12" SHEET.

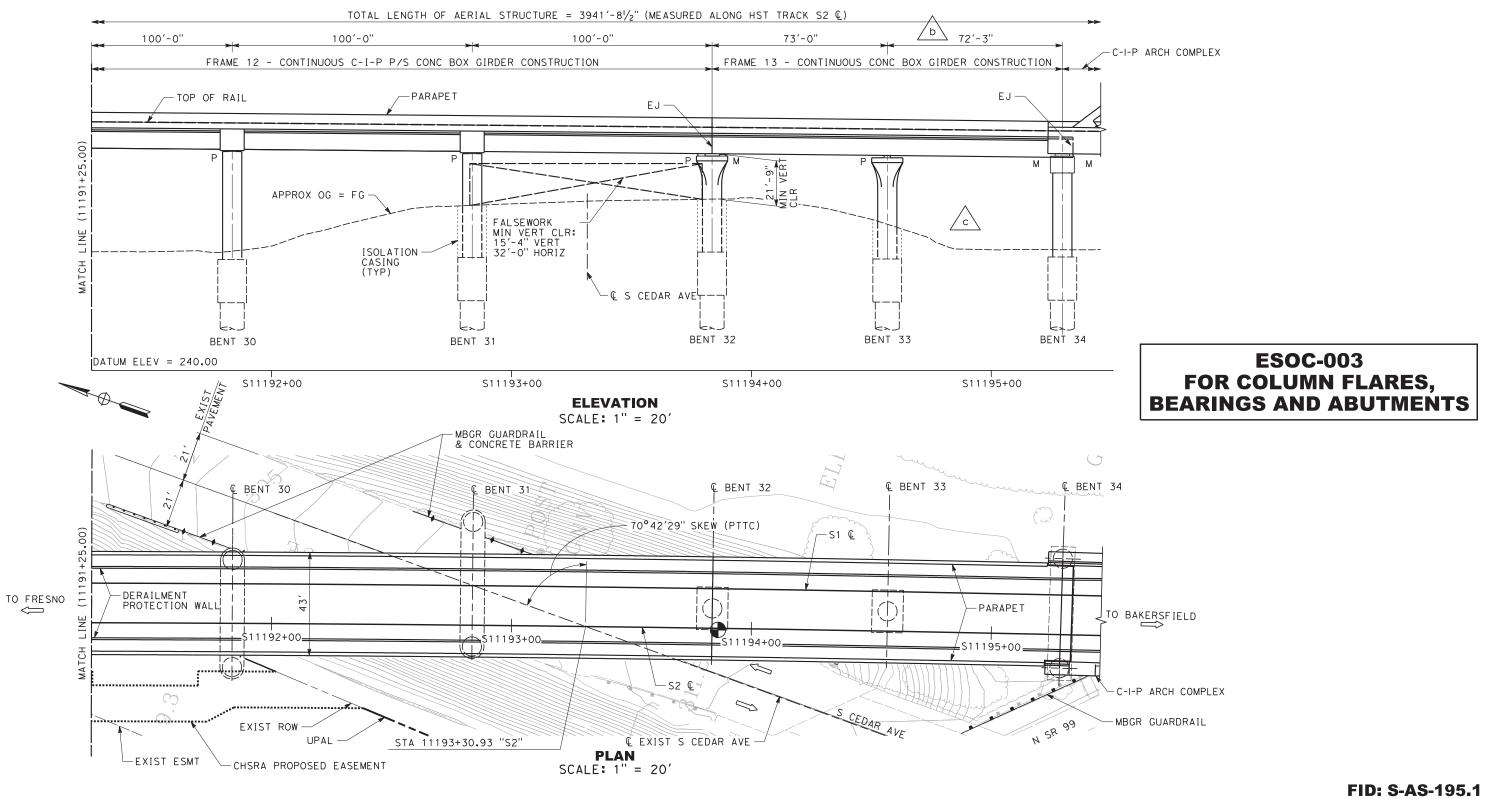

E 08/15/15

F 09/14/16 90% DESIGN SUBMITTAL D. GETTER c | 08/05/16 | DG | SB | DJ | ESOC-003 - COLUMN FLARES, BEARINGS & ABUTMENTS J. GILMORE ь | 04/08/16 | DG | DJ | DJ | ESOC-002 - BENT FOUNDATIONS & COLUMNS CHECKED BY CONSTRUCTION a 11/13/15 SD FN SD ESOC-001 - FOUNDATIONS ONLY D. JONES 60% DESIGN SUBMITTAL 09/14/2016

CALIFORNIA HIGH-SPEED TRAIN PROJECT CP-I AGREEMENT NO.4 HSR3-O6 SUBMITTAL REVIEW IN ACCORDANCE WITH BOOK 2, PART B - GENERAL PROVISIONS - SECTION 6L2

Tutor Perini ZACHRY **PARSONS** A joint venture



CALIFORNIA HIGH-SPEED TRAIN PROJECT CONSTRUCTION PACKAGE 1

DOWNTOWN FRESNO VIADUCT GENERAL PLAN AND ELEVATION SHEET 7 OF 12

CONTRACT NO. HSR13-06
DRAWING NO. ST-J1106-DFV
SCALE 1" = 20'
SHEET NO.

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CALIFORNIA HIGH-SPEED
TRAIN PROJECT CP-1
AGREEMENT NO₂ HSRI3-O6
SUBMITTAL REVIEW IN
ACCORDANCE WITH BOOK 2,
PART B - GENERAL
PROVISIONS - SECTION 6L2
APPROVED
SIGNED






CALIFORNIA HIGH-SPEED TRAIN PROJECT CONSTRUCTION PACKAGE 1

DOWNTOWN FRESNO VIADUCT GENERAL PLAN AND ELEVATION SHEET 8 OF 12

_	A0-19311
	CONTRACT NO. HSR13-06
	ST-J1107-DFV
	SCALE 1" = 20'
	SHEET NO.

NOTE:

1. FOR NOTES, TOP OF RAIL PROFILE, AND LEGEND, SEE "GENERAL PLAN AND ELEVATION SHEET 1 OF 12" SHEET.

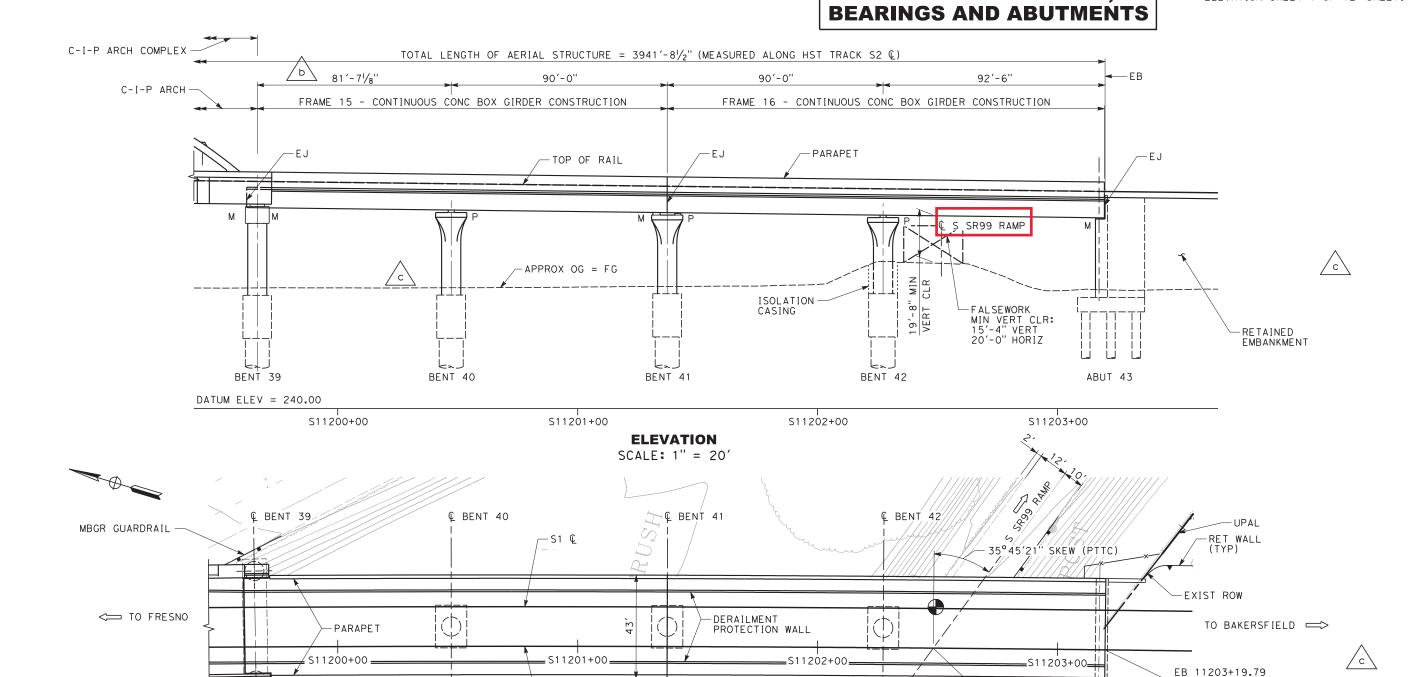

PLAN SCALE: 1" = 20'

MBGR GUARDRAÍL

FID: S-AS-195.1

16/	F	09/14/16				90% DESIGN SUBMITTAL	D. GETTER	
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	b	04/08/16	DG	DJ	DJ	ESOC-002 - BENT FOUNDATIONS & COLUMNS	J. GILMORE CHECKED BY	
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C-I-P ARCH COMPLEX

NOT FOR ONSTRUCTION

−S2 €

CALIFORNIA HIGH-SPEED TRAIN PROJECT CP-I AGREEMENT NO.1 HSRI3-06 SUBMITTAL REVIEW IN ACCORDANCE WITH BOOK 2, PART B - GENERAL PROVISIONS - SECTION 61.2

Tutor Perini ZACHRY **PARSONS** A joint venture



CALIFORNIA HIGH-SPEED TRAIN PROJECT CONSTRUCTION PACKAGE 1

ELEV 330.50, TOR S2

- CHSRA PROPOSED EASEMENT

-UPAI

& BRG ABUT 43

STA 11202+48.20 "S2" =

€ S SR99 RAMP EXIST ROW

- C S SR99 RAMP

DOWNTOWN FRESNO VIADUCT GENERAL PLAN AND ELEVATION SHEET 9 OF 12

CONTRACT NO. HSR13-06
DRAWING NO.
ST-J1108-DFV
SCALE
1" = 20'
SHEET NO.



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STRUCTURE

& COL

43'-0"

(TÝP)

SECTION AT TYPICAL VIADUCT BENT

SCALE: 1" = 10'

TRACK

10'-8"

13'-3"

TOR

31'-01/2" MIN

& VARIES

47'-0" MIN

& VARIES

UPAL

42'-11" MIN

& VARIES |

OCS POLE

-8' Ø CONC COL

2'-0" OPNG AROUND

-12'Ø CMP CASING AT TOP OF SHAFT

−10′ø CIDH SHAFT

27'-111/2" MIN

& VARIES

10'-8"

13'-3"

TRACK

S2 Q

CHSRA TCE

CABLE TROUGH WALL

WALKWAY AND CABLE TROUGH (TYP)

PARAPET (TYP)

CHSRA TCE

MIN WALKWAY CLEARANCE

DERAILMENT

PROTECTION

C-I-P P/S CONC

COLUMN FLARE

(TYP)

ISOLATION CASING, SEE CP1 STANDARD CONSTRUCTION DWG NO. STSP-005 FOR

SEE DRAWING NO. ST-J5337-DFV FOR BENT 32

BENTS 33 & 42

BOX GIRDER

APPROX OG = FG

WALL (TYP)

ENVELOPE 3'-0"X7'-6"

UPAL


CALIFORNIA HIGH-SPEED TRAIN PROJECT CP-I AGREEMENT NO.1 HSRI3-06 SUBMITTAL REVIEW IN ACCORDANCE WITH BOOK 2, PART B - GENERAL PROVISIONS - SECTION 61.2 NOT FOR CONSTRUCTION





NOTE:

- 1. THE FOLLOWING ITEMS ARE SHOWN FOR ILLUSTRATION PURPOSES ONLY AND ARE NOT INCLUDED IN THE CONTRACT:
 - A. OCS POLES, BASE PLATES AND GROUT PAD.
- B. CABLE TROUGH PRE-CAST COVERS, INTERMEDIATE WALLS AND BASE SLABS.
- C. DIRECT FIXATION RAIL SYSTEM AND TRACK SLAB.
- 2. FOR OTHER NOTES AND LEGEND, SEE "GENERAL PLAN AND ELEVATION SHEET 1 OF 12" SHEET.

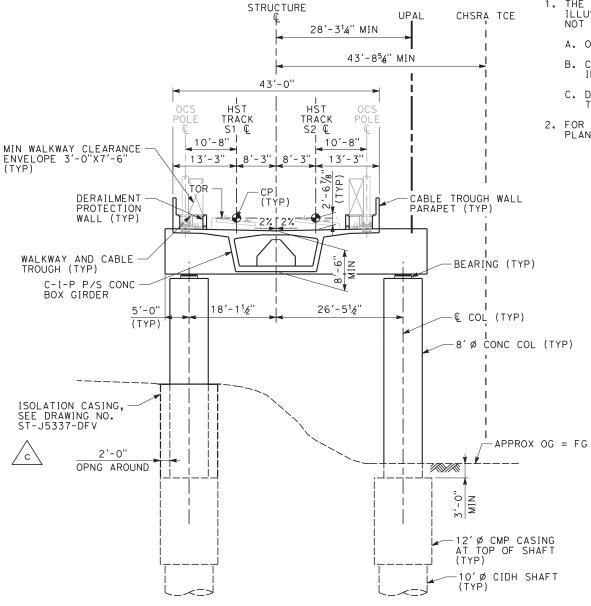

SECTION AT BENT 30

SCALE: 1" = 10'

ESOC-003 FOR COLUMN FLARES, **BEARINGS AND ABUTMENTS**

FID: S-AS-195.1

CALIFORNIA HIGH-SPEED TRAIN PROJECT CONSTRUCTION PACKAGE 1

DOWNTOWN FRESNO VIADUCT GENERAL PLAN AND ELEVATION SHEET 10 OF 12

CONTRACT NO. HSR13-06
DRAWING NO. ST-J1109-DFV
SCALE 1" = 10'
SHEET NO.

F 09/14/16 90% DESIGN SUBMITTAL D. GETTER c | 08/05/16 | DG | SB | DJ | ESOC-003 - COLUMN FLARES, BEARINGS & ABUTMENTS J. GILMORE ь | 04/08/16 | DG | DJ | DJ | ESOC-002 - BENT FOUNDATIONS & COLUMNS CHECKED BY a | 11/13/15 | SD | FN | SD | ESOC-001 - FOUNDATIONS ONLY D. JONES E 08/15/15 60% DESIGN SUBMITTAL 09/14/2016

SCALE: 1" = 10'

CALIFORNIA HIGH-SPEED TRAIN PROJECT CP-I AGREEMENT NO.4 HSR3-O6 SUBMITTAL REVIEW IN ACCORDANCE WITH BOOK 2, PART B - GENERAL PROVISIONS - SECTION 6L2 NOT FOR CONSTRUCTION


Tutor Perini ZACHRY **PARSONS** A joint venture



CALIFORNIA HIGH-SPEED TRAIN PROJECT CONSTRUCTION PACKAGE 1

DOWNTOWN FRESNO VIADUCT GENERAL PLAN AND ELEVATION SHEET 11 OF 12

HSR13-06 RAWING NO. ST-J1110-DFV 1" = 10' SHEET NO.

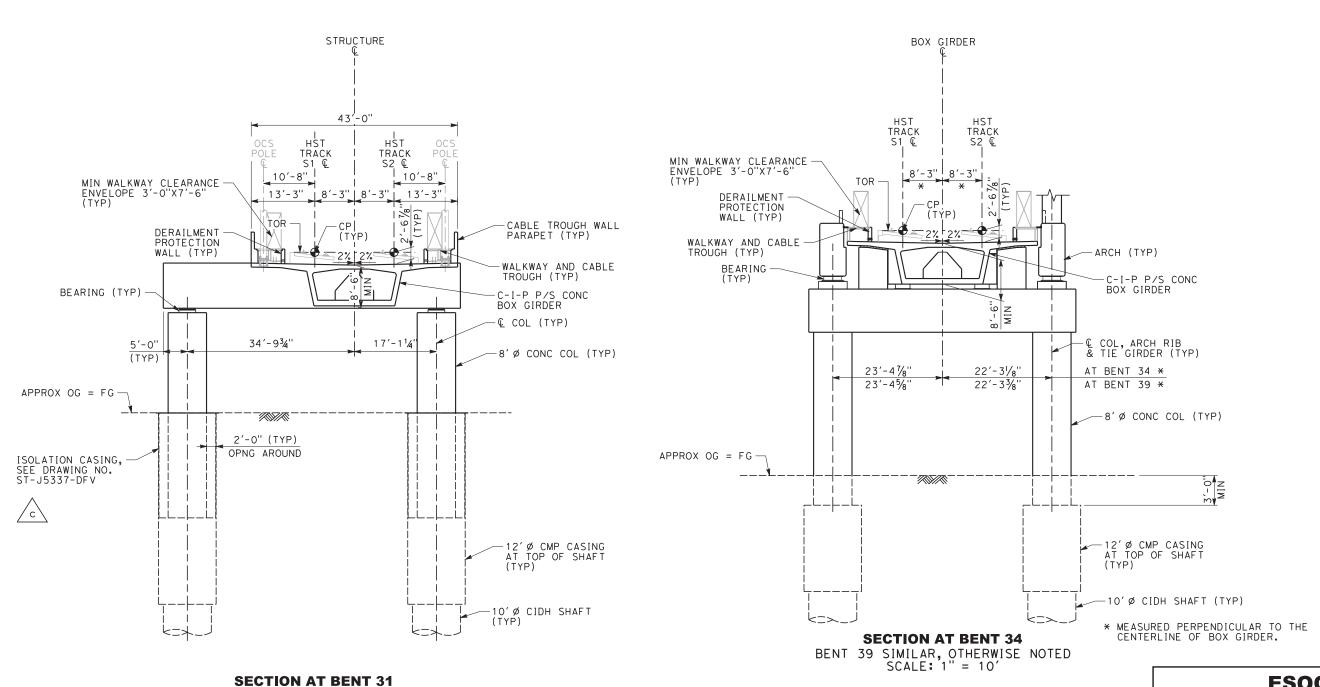


ESOC-003 FOR COLUMN FLARES, **BEARINGS AND ABUTMENTS**

FID: S-AS-195.1

NOTE:





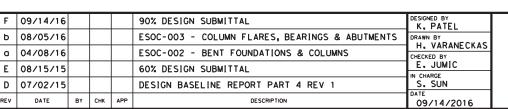

STRUCTURE

43[']-6"

(TYP)

SECTION AT BENT 35

SCALE: 1" = 10'

BENT 38 SIMILAR, OPPOSITE HAND

OCS POLE Q

10'-8"

VARIES

-67/8 MIN

22'-10"

HST TRACK S2 €

HST TRACK S1 &

10'-8"]

22'-10"

3'-0" MIN

| |VARIES

POLE

© COL, ARCH RIB-& TIE GIRDER

ARCH RIB (TYP)

DERAILMENT PROTECTION
WALL (TYP)
STEEL ANGLE
(TYP)

BEARING (TYP)

8' Ø CONC COL

APPROX OG = FG

12' Ø CMP CASING AT TOP OF SHAFT

10' Ø CIDH SHAFT —

MIN WALKWAY CLEARANCE -ENVELOPE 3'-0"X7'-6" (TYP)

ARCH RIB (TYP)


-PARAPET (TYP)

TIE GIRDER (TYP)







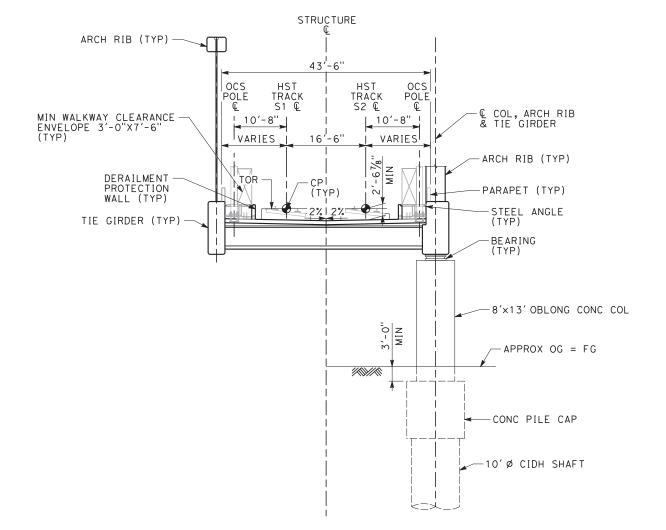

SECTION AT BENT 36

BENT 37 SIMILAR, OPPOSITE HAND SCALE: 1" = 10'

ESOC-003 FOR COLUMN FLARES, **BEARINGS AND ABUTMENTS**

FID: S-AS-195.1

CALIFORNIA HIGH-SPEED TRAIN PROJECT CONSTRUCTION PACKAGE 1


DOWNTOWN FRESNO VIADUCT GENERAL PLAN AND ELEVATION SHEET 12 OF 12


CONTRACT NO. HSR13-06
ST-J1111-DFV
SCALE 1" = 10'
SHEET NO.

Exhibit B

Project Drawings

Exhibit B3 – Guideway Drawings

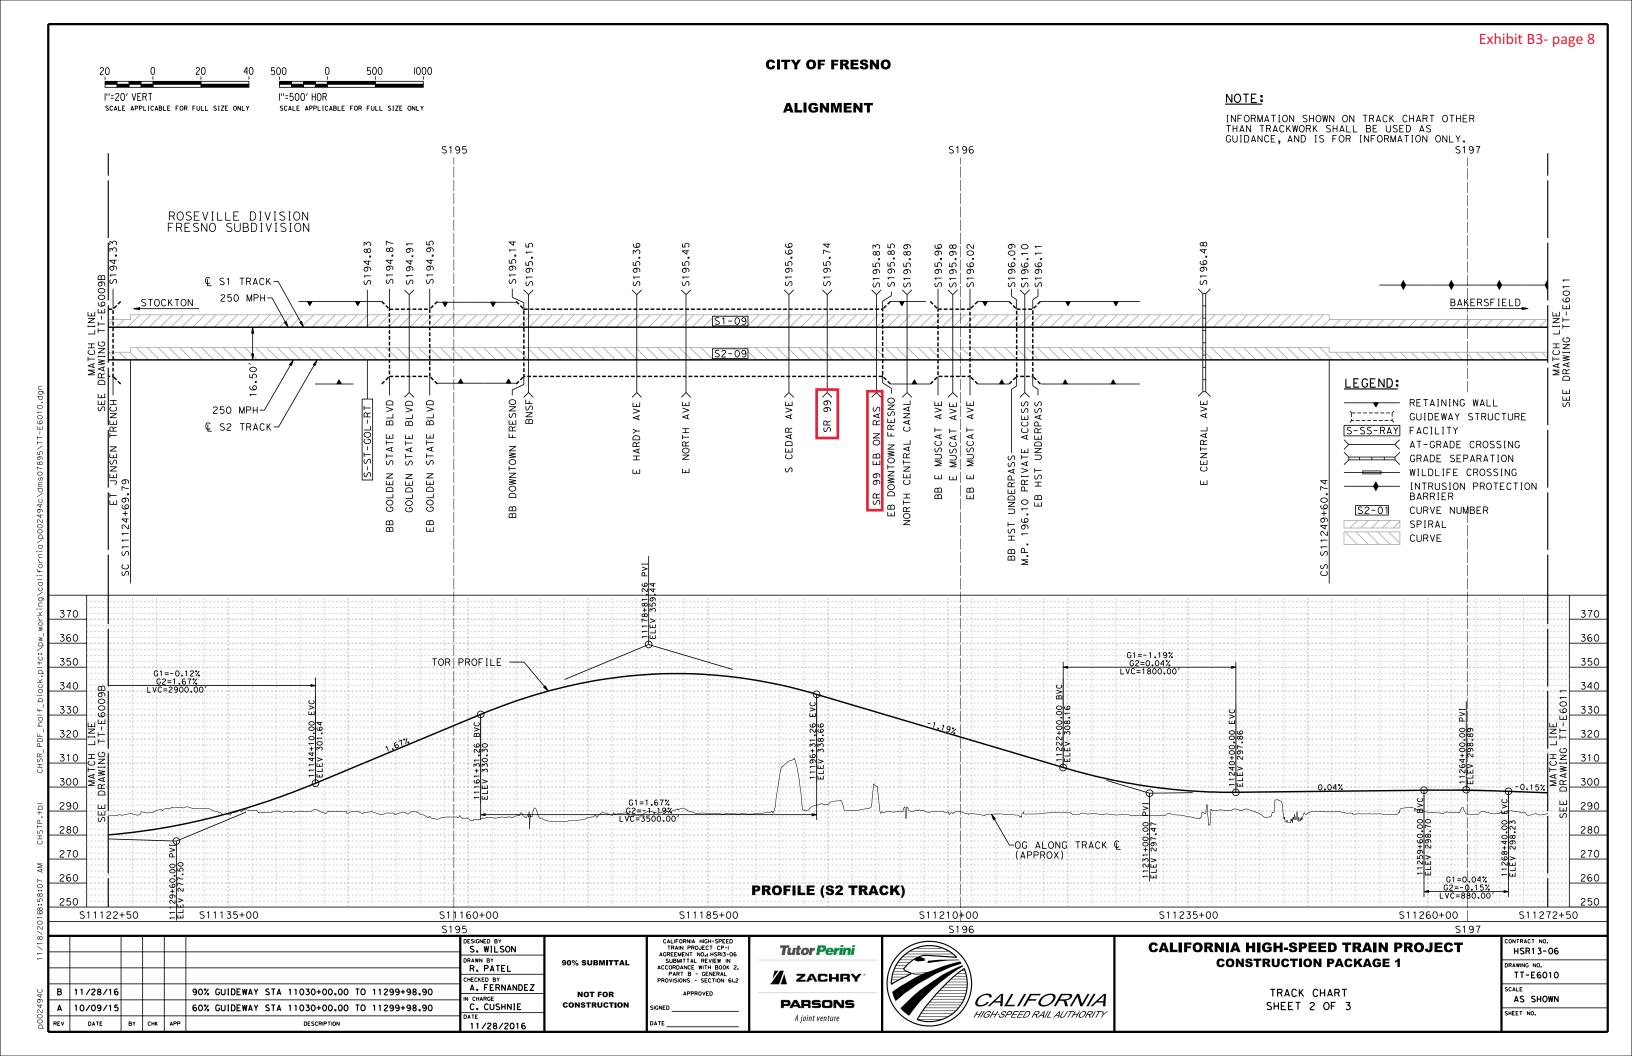

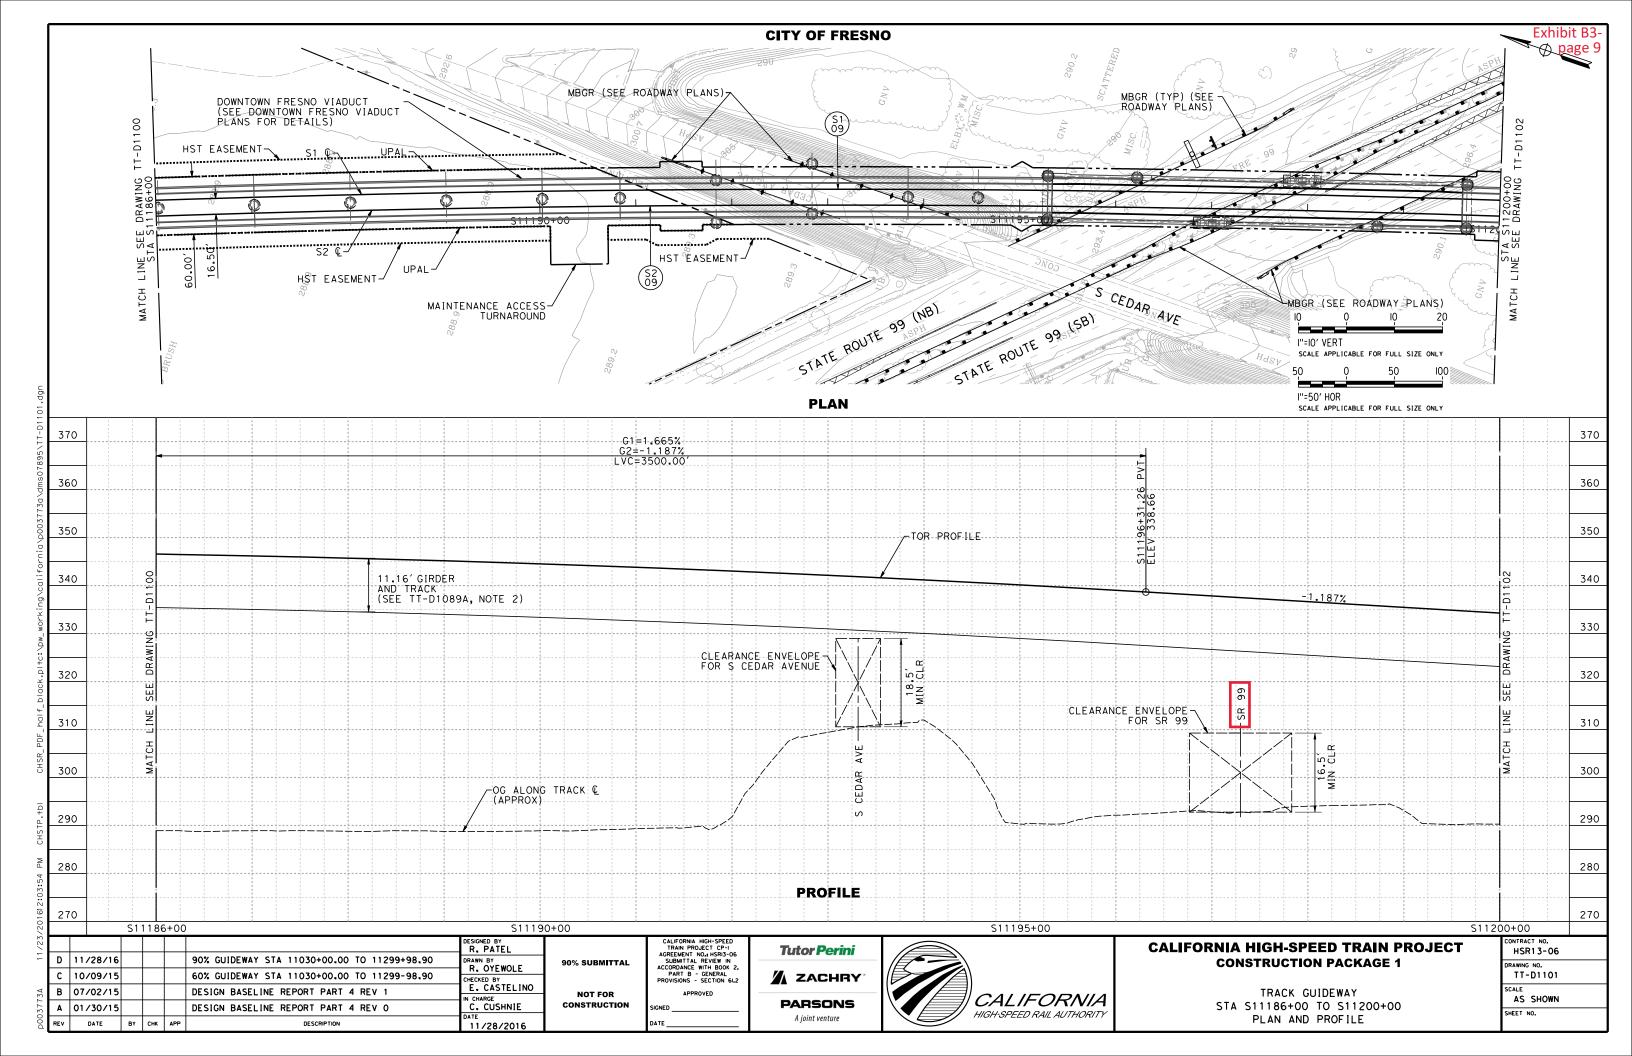

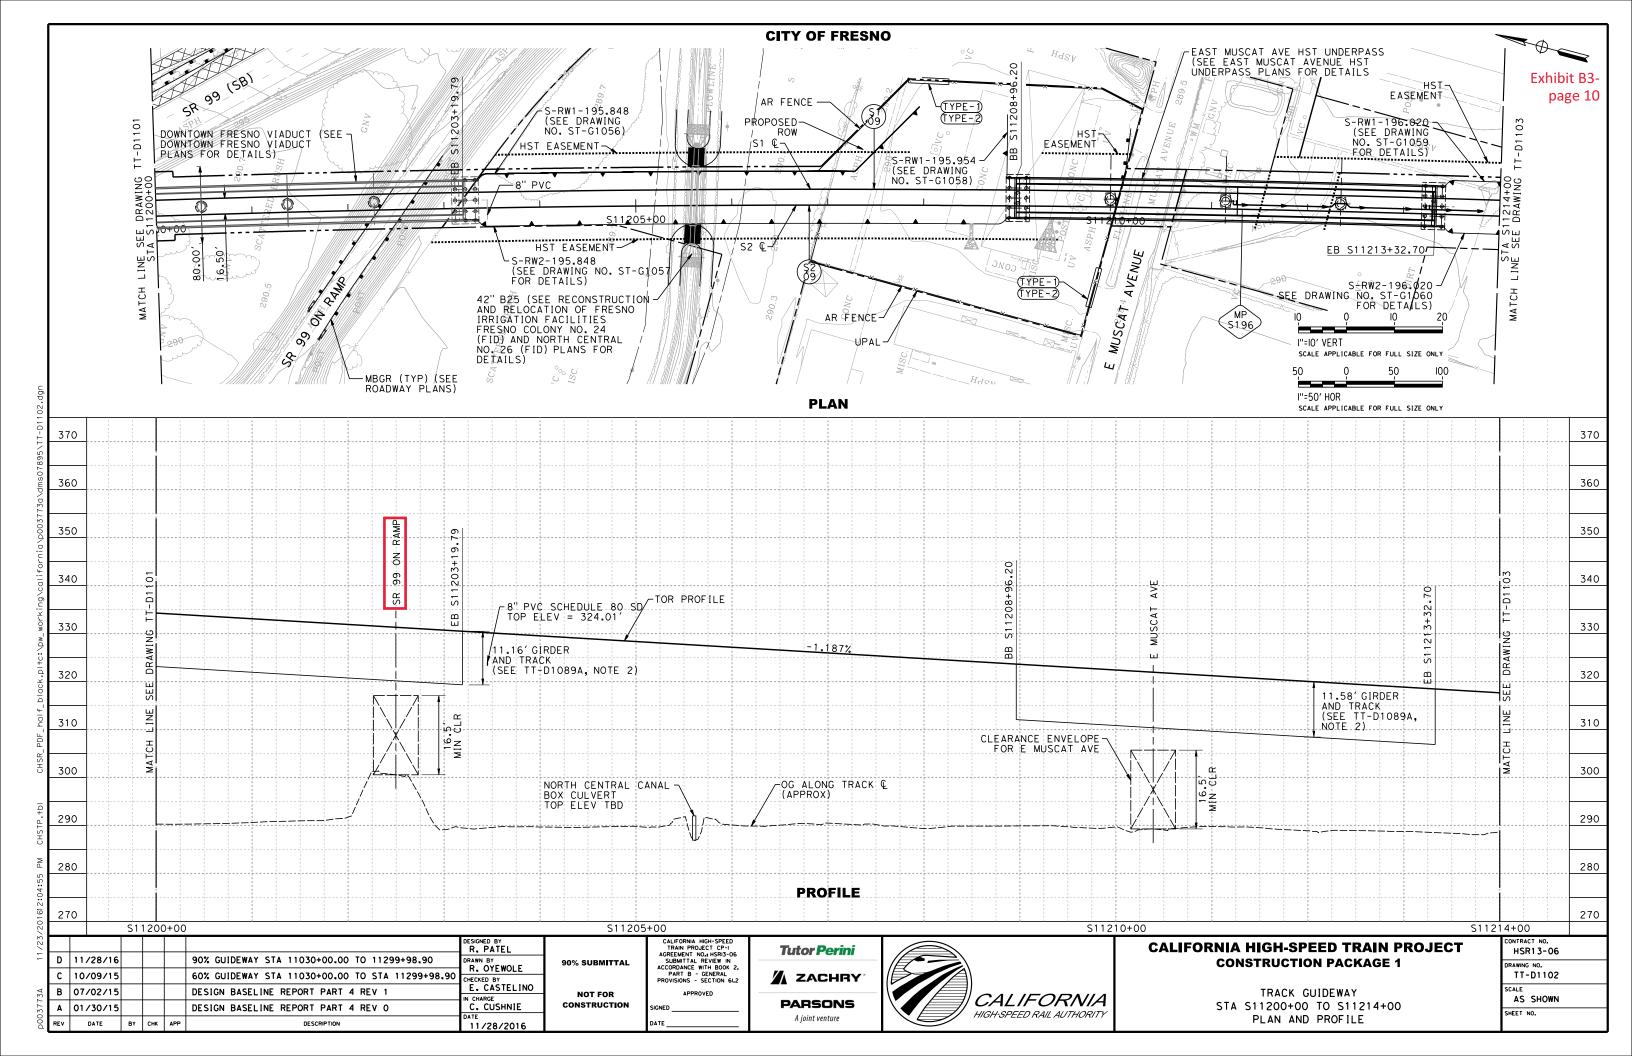


Exhibit C

Local Project Support

Caltrans Concurrence

I, Garth Fernandez, an employee of the California Department of Transportation (Caltrans) and authorized to sign this letter of agreement on its behalf, hereby declare that Caltrans concurs with the proposed CP1 Project at the Downtown Fresno Viaduct as described in the Supplemental Project Report dated February 3, 2017 for the HST encroachments at E. North/S. Cedar Avenues, State Route 99, and Southbound On-Ramp (PM 16.9-17.2).

Garth Fernandez

Project Manager

Date

California Department of Transportation

2015 E. Shields Ave, Suite 100

Fresno, CA 93726

Exhibit D

Scoping Memo

Scoping Memo Information for Applications

A. Category (Check the category that is most appropriate)
Adjudicatory - "Adjudicatory" proceedings are: (1) enforcement investigations into possible violations of any provision of statutory law or order or rule of the Commission; and (2) complaints against regulated entities, including those complaints that challenge the accuracy of a bill, but excluding those complaints that challenge the reasonableness of rates or charges, past, present, or future, such as formal rough crossing complaints (maximum 12 month process if hearings are required).
Ratesetting - "Ratesetting" proceedings are proceedings in which the Commission sets or investigates rates for a specifically named utility (or utilities), or establishes a mechanism that in turn sets the rates for a specifically named utility (or utilities). "Ratesetting" proceedings include complaints that challenge the reasonableness of rates or charges, past, present, or future. Other proceedings may also be categorized as ratesetting when they do not clearly fit into one category, such as railroad crossing applications (maximum 18 month process if hearings are required).
Quasi-legislative - "Quasi-legislative" proceedings are proceedings that establish policy or rules (including generic ratemaking policy or rules) affecting a class of regulated entities, including those proceedings in which the Commission investigates rates or practices for an entire regulated industry or class of entities within the industry.
B. Are hearings necessary? If yes, identify the material disputed factual issues on which hearings should be held, and the general nature of the evidence to be introduced. Railroad crossing applications which are not controversial usually do not require hearings.

Are public witness hearing	gs necessary? Yes	No No	
Public witness hearings are set up for the purpose of getting input from the general public and any entity that will not be a party to the proceeding. Such input usually involves presenting written or oral statements to the presiding officer, not sworn testimony. Public witness statements are not subject to cross-examination.			
C. Issues - List here the s	specific issues that need to	be addressed in the proceeding.	
to hold hearings, indicative within 12 months (if contracted ratesetting or quasi-legation)	ate here the proposed sche categorized as adjudicatory gislative).	ve) Should the Commission decide edule for completing the proceeding y) or 18 months (if categorized as following events as needed:	
August 23, 2017 September 22, 2017 December 22, 2017 February 23, 2018 If hearings unexpectedly be	_Filing Date _Comment Period _Proposed Decision (4 moi _Final Decision (6 months	nths from filing)	
February 23, 2018 May 24, 2018 August 22, 2018 September 21, 2018 December 20, 2018 February 22, 2019	_Prehearing conference _Hearings _Briefs due _Submission _Proposed decision (90 da _Final decision (60 days af	ys after submission) ter proposed decision is mailed)	

Exhibit EVerification

I am an officer of the California High-Speed Rail Authority, Applicant herein, and am authorized to make this verification on its behalf. The contents of this document are true of my own knowledge, except as matters that are stated on information or belief, and as to those matters, I believe them to be true.

Dated this 28 day of 11, 2017 at Sacramento, California.

Signed_

Bruce W. Armistead

Director of Operations and Maintenance

California High-Speed Rail Authority

770 L Street, Suite 620 Sacramento, CA 95814

Tel: (916) 324-1541